

CONSTRUCTION PLANS  
FOR  
**CITY OF TYLER**  
**P. T. COLE PARK**  
**TYLER, TEXAS**  
SMITH COUNTY  
October 2022

REVISIONS:



212 West Ninth Street, Tyler, Texas 75701  
903.597.6606 TIBPE No. 14571

**COVER SHEET**

**P.T. COLE PARK**  
CITY OF TYLER, TEXAS

**MAYOR**

DON WARREN

**CITY COUNCIL**


STUART HENE  
BRODERICK MCGEE  
SHIRLEY MCKELLAR  
JAMES WYNNE  
BOB WESTBROOK  
BRAD CURTIS

**CITY MANAGER**

EDWARD BROUSSARD

**PARKS DIRECTOR**

LEANNE ROBINETTE

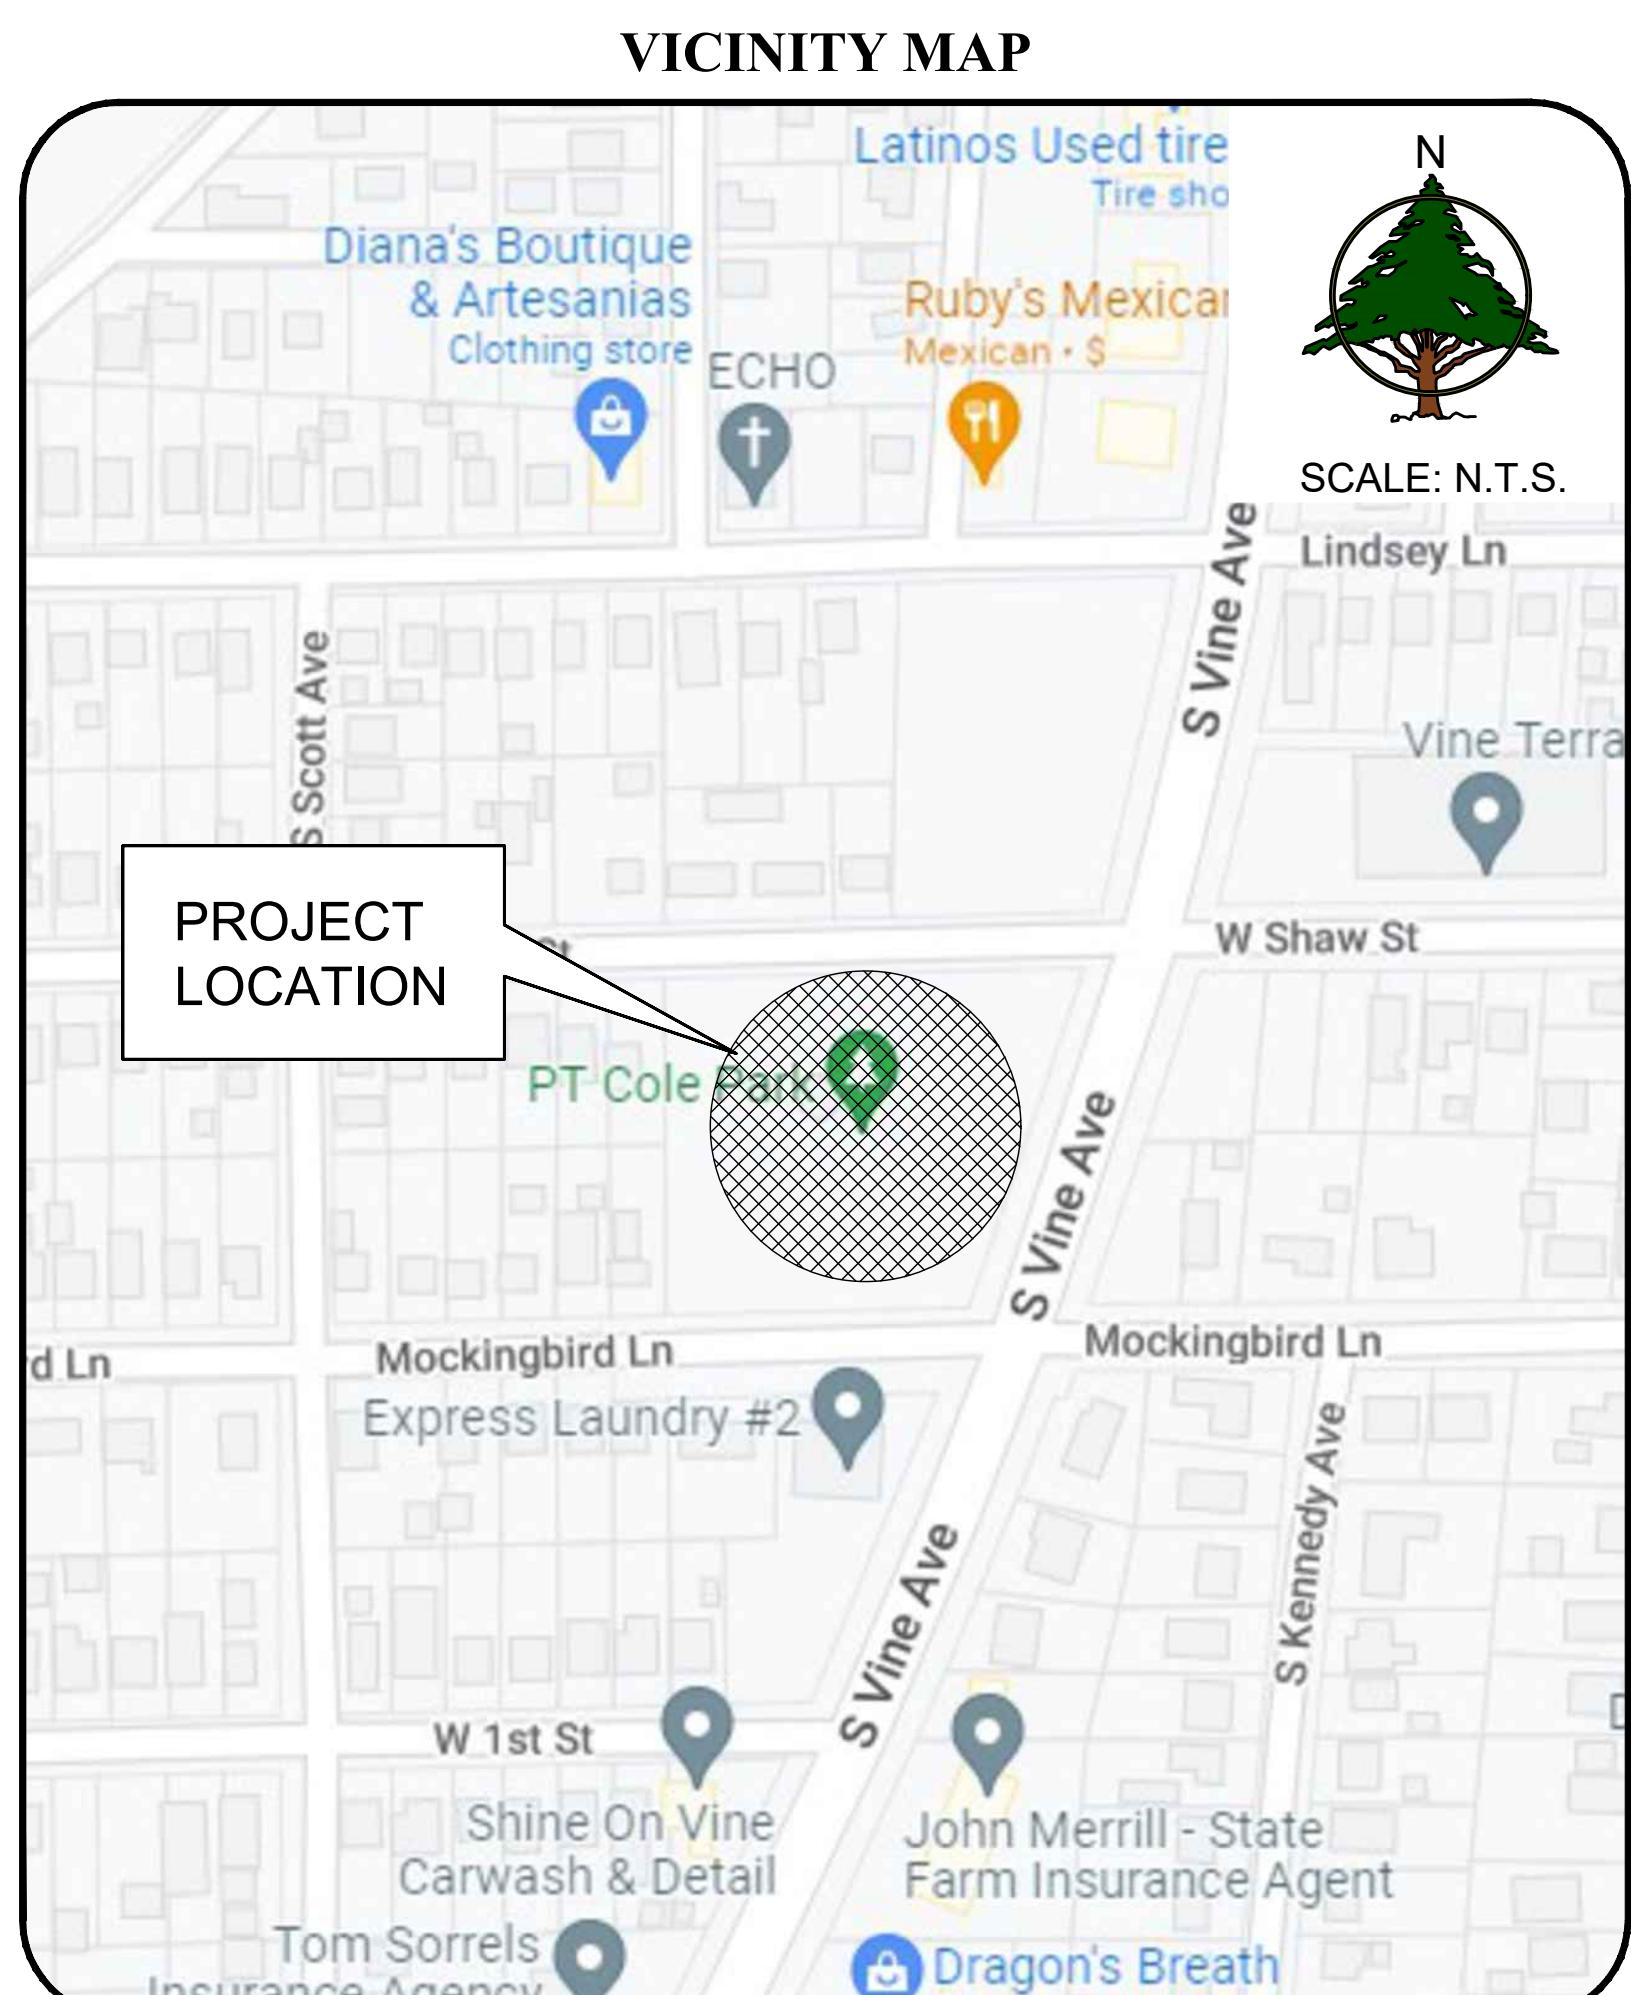

**SHEET INDEX**


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DRAWN: JHD  
CHECKED: WHS  
DATE: 10/11/2022  
SCALE: AS SHOWN  
JOB NO.: 22-069



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C1



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903-597-6606
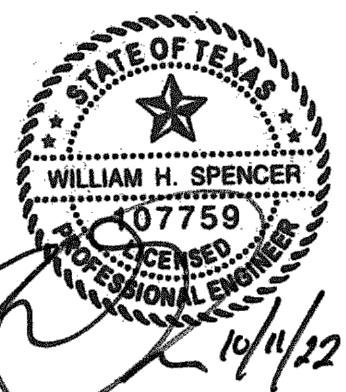
## P.T. COLE PARK CITY OF TYLER, TEXAS

## GENERAL NOTES

### GENERAL CONSTRUCTION NOTES:

- ALL EXISTING UTILITIES MAY NOT BE SHOWN AND THE ACTUAL UTILITY LOCATIONS MAY VARY FROM THE LOCATIONS SHOWN ON THESE PLANS. THE CONTRACTOR IS RESPONSIBLE FOR VERIFYING ALL UTILITIES AND NOTIFYING THE APPROPRIATE UTILITY COMPANY PRIOR TO BEGINNING CONSTRUCTION.
- THESE PLANS ARE BASED ON A TOPOGRAPHIC SURVEY PROVIDED BY FREEMAN SURVEYING & MAPPING, LLC. THE CONTRACTOR SHALL NOTIFY THE ENGINEER IMMEDIATELY, IN WRITING, OF ANY DISCREPANCIES OR OMISSIONS TO THE TOPOGRAPHIC INFORMATION. THE CONTRACTOR(S) SHALL BE RESPONSIBLE FOR CONFIRMING THE LOCATION (HORIZONTAL/VERTICAL) OF ANY BURIED CABLES, CONDUITS, PIPES, AND STRUCTURES (STORM SEWER, SANITARY SEWER, WATER, GAS, TELEVISION, TELEPHONE, ETC.) WHICH IMPACT THE CONSTRUCTION SITE. THE CONTRACTOR(S) SHALL NOTIFY THE OWNER AND ENGINEER IF ANY DISCREPANCIES ARE FOUND BETWEEN THE ACTUAL CONDITIONS VERSUS THE DATA CONTAINED IN THE CONSTRUCTION PLANS. ANY COSTS INCURRED AS THE RESULT OF NOT CONFIRMING THE ACTUAL LOCATION (HORIZONTAL/VERTICAL) OF SAID CABLES, CONDUITS, PIPES, AND STRUCTURES SHALL BE BORNE BY THE CONTRACTOR. ADDITIONALLY, THE CONTRACTOR(S) SHALL NOTIFY THE OWNER AND ENGINEER IF ANY ERRORS OR DISCREPANCIES ARE FOUND ON THE CONSTRUCTION DOCUMENTS (PS&E), WHICH NEGATIVELY IMPACT THE PROJECT. THE ENGINEER AND OWNER SHALL BE INDEMNIFIED OF PROBLEMS AND/OR COST WHICH MAY RESULT FROM CONTRACTOR'S FAILURE TO NOTIFY ENGINEER AND OWNER.
- CONTRACTOR IS RESPONSIBLE FOR REPAIRS OF DAMAGE TO ANY EXISTING IMPROVEMENTS DURING CONSTRUCTION, SUCH AS, BUT NOT LIMITED TO, DRAINAGE, PAVEMENT, STRIPING, CURB, SIDEWALKS, DRIVEWAYS, FENCES, ETC. REPAIRS SHALL BE EQUAL TO OR BETTER THAN EXISTING CONDITIONS. DAMAGE TO ANY UTILITY SHALL BE REPAIRED BY THE UTILITY OWNER BUT AT CONTRACTOR'S EXPENSE.
- CONTRACTOR SHALL COMPLY TO THE FULLEST EXTENT WITH THE LATEST STANDARDS OF OSHA DIRECTIVES OR ANY OTHER AGENCY HAVING JURISDICTION FOR EXCAVATION AND TRENCHING PROCEDURE. CONTRACTOR SHALL USE SUPPORT SYSTEMS, SLOPING, BENCHING, AND OTHER MEANS OF PROTECTION. THIS IS TO INCLUDE, BUT NOT LIMITED TO, ACCESS AND EGRESS FROM ALL EXCAVATION AND TRENCHING. CONTRACTOR IS RESPONSIBLE TO COMPLY WITH PERFORMANCE CRITERIA FOR OSHA.
- ALL WORK ON THESE PLANS SHALL BE DONE IN STRICT ACCORDANCE WITH THE SPECIFICATIONS.
- DURING CONSTRUCTION OF THESE IMPROVEMENTS, ANY DEVIATION FROM THESE SPECIFICATIONS WILL REQUIRE APPROVAL IN WRITING FROM THE OWNER AND HIS DESIGNEE BEFORE ANY CONSTRUCTION INVOLVING THAT DECISION COMMENCES.
- CONSTRUCTION SHALL COMPLY WITH ALL GOVERNING CODES AND REQUIREMENTS. CONTRACTOR SHALL CONDUCT ALL REQUIRED TESTS TO THE SATISFACTION OF THE UTILITY COMPANIES AND OWNER'S INSPECTING AUTHORITIES.
- THE CONTRACTOR SHALL ASSUME RESPONSIBILITY FOR THE PROTECTION OF ALL PROPERTY CORNER MONUMENTS, AND SHALL HAVE REPLACED, AT CONTRACTOR'S EXPENSE, ALL CORNER MONUMENTS WHICH ARE DISTURBED BY CONSTRUCTION ACTIVITIES.

### EROSION CONTROL NOTES:

- EROSION CONTROL MEASURES SHALL BE REQUIRED DURING ALL PHASES OF CONSTRUCTION AND MAINTAINED TO FULLY FUNCTION UNTIL NO LONGER REQUIRED FOR A COMPLETED PHASE OF WORK OR FINAL STABILIZATION OF THE SITE. ADDITIONAL EROSION CONTROL MEASURES MAY BE REQUIRED THAN WHAT IS SHOWN ON THE PLANS.
- THE CONTRACTOR IS RESPONSIBLE FOR PREPARING AND IMPLEMENTING A STORMWATER POLLUTION PREVENTION PLAN IN ACCORDANCE WITH THE TPDES.
- CONTRACT SHALL PLACE STABILIZATION FABRIC ON ALL SLOPES STEEPER THAN 3H:1V. CONTRACTOR SHALL PLACE FOUR (4) INCHES OF TOPSOIL (LOOSE) ON ALL UNSURFACED AREAS DISTURBED BY GRADING OPERATIONS UNLESS OTHERWISE NOTED ON LANDSCAPE PLANS. SEED OR SOIL ALL DISTURBED AREAS IN ACCORDANCE WITH THE SPECIFICATIONS AND MAINTAIN SAME UNTIL A HEALTHY STAN OF GRASS IS OBTAINED. THE SPECIFIC PLANT MATERIALS PROPOSED TO PROTECT FILL AND EXCAVATED SLOPES SHALL BE SUITABLE FOR USE UNDER LOCAL CLIMATE AND SOIL CONDITIONS. IN GENERAL, HYDROSEEDING OR SODDING BERMUDA GRASS IS ACCEPTABLE DURING THE SUMMER MONTHS (MAY 1ST TO AUGUST 31ST). WINTER RYE OR FESCUE GRASS MAY BE PLANTED DURING TIMES OTHER THAN THE SUMMER MONTHS AS A TEMPORARY MEASURE UNTIL SUCH TIME AS THE PERMANENT PLANTING CAN BE MADE.
- AS INLETS ARE COMPLETED, TEMPORARY SEDIMENT BARRIERS SHALL BE INSTALLED.
- AT COMPLETION OF THE PAVING AND FINAL GRADING, THE DISTURBED AREA(S) SHALL BE REVEGETATED IN ACCORDANCE WITH THE PLANS.
- SILT FENCE AND INLET SEDIMENT BARRIERS SHALL REMAIN IN PLACE UNTIL REVEGETATION HAS BEEN COMPLETED.
- DISTURBED AREAS THAT ARE SEEDED OR SODDED SHALL BE CHECKED PERIODICALLY TO SEE THAT GRASS COVERAGE IS PROPERLY MAINTAINED. DISTURBED AREAS SHALL BE WATERED, FERTILIZED, AND RE-SEEDED OR RE-SODDED, IF NECESSARY.
- THERE IS TO BE ONE CONCRETE WASH-OUT PIT LOCATED ON THE SITE. THE LOCATION OF THIS WASH-OUT PIT IS TO BE DETERMINED BY THE CONTRACTOR AND APPROVED BY THE ENGINEER. IT WILL BE THE RESPONSIBILITY OF THE CONTRACTOR TO PROPERLY DISPOSE OF ALL EXCESS CONCRETE MATERIAL.
- LOCATION OF CONSTRUCTION EXITS SHALL BE PLACED IN THE FIELD AND APPROVED BY THE ENGINEER.
- THE CONTRACTOR WILL BE REQUIRED TO FILE A NOTICE OF INTENT (NOI) PRIOR TO COMMENCEMENT OF CONSTRUCTION AND MONITOR SITE EROSION THROUGHOUT THE CONSTRUCTION PROCESS. ONCE THE PROJECT IS COMPLETED, THE CONTRACTOR SHALL FILE THE REQUIRED NOTICE OF TERMINATION (NOT) WITH THE EPA.
- ALL WASTE MANAGEMENT PRACTICES (EXISTING HAZARDOUS WASTE, SOLID WASTE, CONCRETE WASTE, ETC.) SHALL COMPLY WITH TCEQ REQUIREMENTS.

### DEMOLITION NOTES:

- NO EARTH-DISTURBING ACTIVITIES SHALL COMMENCE UNTIL ALL PERIMETER EROSION CONTROL MEASURES ARE IN PLACE IN ACCORDANCE WITH THE STORM WATER POLLUTION PREVENTION PLAN SITE MAP OR EROSION CONTROL PLAN AND THE SPECIFICATIONS.
- CONTRACTOR SHALL COMPLY TO THE FULLEST EXTENT WITH ALL REGULATIONS GOVERNING THE DEMOLITION, REMOVAL, TRANSPORTATION, AND DISPOSAL OF ALL DEMOLITION DEBRIS.
- THE CONTRACTOR SHALL COMPLY WITH ALL OSHA REQUIREMENTS FOR DEMOLITION OF STRUCTURES.
- NOTES SHOWN HEREON REGARDING SPECIFIC ITEMS OF DEMOLITION ARE GENERAL IN NATURE, AND ARE NOT INTENDED TO BE WHOLLY INCLUSIVE.
- THE CONTRACTOR SHALL BE RESPONSIBLE FOR VISITING THE SITE AND DETERMINING THE EXTENT OF EXISTING IMPROVEMENTS TO BE REMOVED FROM THE SITE.
- THE CONTRACTOR SHALL BE RESPONSIBLE FOR COORDINATING WITH THE APPROPRIATE UTILITY COMPANIES ON THE DISCONNECTION OR TERMINATION OF ANY UTILITIES SERVING THIS AREA.
- ALL FENCING AND OTHER MAN-MADE ELEMENTS, ETC., WITHIN CONSTRUCTION AREA, UNLESS OTHERWISE IDENTIFIED, SHALL BE REMOVED AND DISPOSED OF OFF SITE.
- REMOVAL OF ANY TREES OTHER THAN THOSE SPECIFIED IN THESE PLANS SHALL BE COORDINATED WITH THE OWNER. THIS REMOVAL SHALL INCLUDE THE ROOT BALL OF THE TREES.
- THE CONTRACTOR SHALL BE RESPONSIBLE FOR OBTAINING ANY REQUIRED DEMOLITION PERMITS.
- REFER TO THE SPECIFICATIONS FOR ADDITIONAL INFORMATION REGARDING DEMOLITION, SITE PREPARATION AND EARTHWORK FOR THIS PROJECT.

### UTILITY NOTES:

- ALL WATER AND SEWER IMPROVEMENTS SHALL BE DESIGNED, CONSTRUCTED AND TESTED IN ACCORDANCE WITH THE CITY STANDARD SPECIFICATIONS AND CITY STANDARD DETAILS.
- ALL WATER MAINS, UNLESS OTHERWISE NOTED, SHALL HAVE A MINIMUM COVER OF 60 INCHES BELOW TOP OF GRADE. PROVIDE VALVE EXTENSIONS TO ALL VALVES ON LINES DEEPER THAN 60 INCHES.
- WHEN WATER MAINS AND SANITARY SEWERS ARE INSTALLED, THEY SHALL BE INSTALLED NO CLOSER TO EACH OTHER THAN NINE (9) FEET IN ALL DIRECTIONS, AND PARALLEL LINES MUST BE INSTALLED IN SEPARATE TRENCHES. WHERE THE NINE (9) FOOT SEPARATION DISTANCE CANNOT BE ACHIEVED, THE FOLLOWING GUIDELINES SHALL APPLY:
  - WHERE A SANITARY SEWER PARALLELS A WATERLINE, THE SEWER SHALL BE CONSTRUCTED OF CAST IRON, DUCTILE IRON, OR PVC MEETING ASTM SPECIFICATIONS WITH A PRESSURE RATING FOR BOTH THE PIPE AND JOINTS OF 150 PSI. THE VERTICAL SEPARATION SHALL BE A MINIMUM OF TWO FEET BETWEEN OUTSIDE DIAMETERS, AND THE HORIZONTAL SEPARATION SHALL BE A MINIMUM OF FOUR FEET BETWEEN OUTSIDE DIAMETERS. THE SEWER SHALL BE LOCATED BELOW THE WATERLINE.
  - WHERE A SANITARY SEWER CROSSES A WATERLINE AND THE SEWER IS CONSTRUCTED OF CAST IRON, DUCTILE IRON OR PVC WITH A MINIMUM PRESSURE RATING OF 150 PSI, AN ABSOLUTE MINIMUM DISTANCE OF 6 INCHES BETWEEN OUTSIDE DIAMETERS SHALL BE MAINTAINED. IN ADDITION, THE SEWER SHALL BE LOCATED BELOW THE WATERLINE WHERE POSSIBLE AND ONE LENGTH OF THE SEWER PIPE MUST BE CENTERED ON THE WATERLINE.
  - WHERE A SEWER CROSSES UNDER A WATERLINE AND THE SEWER IS CONSTRUCTED OF ABS TRUSS PIPE, SIMILAR SEMI-RIGID PLASTIC COMPOSITE PIPE, CLAY PIPE OR CONCRETE PIPE WITH GASKETED JOINTS, A MINIMUM TWO FOOT SEPARATION DISTANCE SHALL BE MAINTAINED. IN ADDITION, THE SEWER SHALL BE LOCATED BELOW THE WATERLINE WHERE POSSIBLE AND ONE LENGTH OF THE SEWER PIPE MUST BE CENTERED ON THE WATERLINE.
  - WHERE A SEWER CROSSES OVER A WATERLINE, ALL PORTIONS OF THE SEWER WITHIN NINE FEET OF THE WATERLINE SHALL BE CONSTRUCTED OF CAST IRON, DUCTILE IRON OR PVC PIPE WITH A PROCEDURE. THE NEW CONVEYANCE MAY BE ENCASED IN A JOINT OF 150 PSI PRESSURE CLASS PIPE AT LEAST 18 FEET LONG AND TWO NOMINAL SIZES LARGER THAN THE NEW CONVEYANCE. THE SPACE AROUND THE CARRIER PIPE SHALL BE SUPPORTED AT FIVE FEET INTERVALS WITH SPACERS OR BE FILLED TO THE SPRING LINE WITH WASHED SAND. THE ENCASEMENT PIPE SHOULD BE CENTERED ON THE CROSSING AND BOTH ENDS SEALED WITH CEMENT GROUT OR MANUFACTURED SEAL.
  - THE SEWER NEED NOT BE DISTURBED WHERE A NEW WATERLINE IS TO BE INSTALLED PARALLEL TO AN EXISTING SEWER THAT SHOWS NO EVIDENCE OF LEAKAGE AND THE WATERLINE IS INSTALLED ABOVE THE SEWER A MINIMUM OF TWO FEET VERTICALLY AND FOUR FEET HORIZONTALLY. SHOULD EXCAVATION FOR THE WATERLINE PRODUCE EVIDENCE THAT THE SEWER IS LEAKING, THE SEWER MUST BE REPAIRED OR REPLACED AS DESCRIBED IN SUBPARAGRAPHS (A) OR (D) OF THIS PARAGRAPH.
  - THE SEWER NEED NOT BE DISTURBED WHERE A NEW WATERLINE IS TO CROSS OVER (BY 2 FEET OR MORE) EXISTING SEWER SHOWING NO EVIDENCE OF LEAKAGE. SHOULD EXCAVATION FOR THE WATERLINE PRODUCE EVIDENCE THAT THE SEWER IS LEAKING, THEN THE SEWER MUST BE REPAIRED OR REPLACED AS DESCRIBED IN SUBSECTIONS (C) OR (D).
- VALVE BOXES SHALL BE FURNISHED AND SET ON EACH GATE VALVE. AFTER THE FINAL CLEANUP AND ALIGNMENT HAS BEEN COMPLETED, THE CONTRACTOR (UTILITY) SHALL POUR A CONCRETE BLOCK 24"X24"X6" AROUND ALL VALVE BOX TOPS SO THAT THE TOP OF BOX IS LEVEL WITH THE FINISHED GRADE.
- ALL WATER LINES SHALL BE INSTALLED WITH A MINIMUM VERTICAL SEPARATION BETWEEN STORM SEWER OF EIGHTEEN (18) INCHES. CONTRACTOR SHALL BE RESPONSIBLE FOR ADDING 45-DEG. BENDS WHERE NECESSARY TO ROUTE PROPOSED WATER LINES AROUND PROPOSED SANITARY OR STORM SEWERS.
- CITY UTILITY STANDARD DETAILS AND SPECIFICATIONS SHALL TAKE PRECEDENCE OVER THE ON SITE CONSTRUCTION DETAILS AND SITE WORK SPECIFICATIONS FOR ALL WORK SHOWN HEREIN.
- WATER AND SANITARY SEWER IMPROVEMENTS MUST BE CONSTRUCTED UNDER A 3-WAY CONTRACT USING AN APPROVED UTILITY CONTRACTOR AND IN ACCORDANCE WITH CITY OF TYLER CODE OF ORDINANCE SECTION 19-11 THROUGH 19-17.
- FIRE HYDRANTS SHALL BE PLACED 2' TO 6' FROM BACK OF CURB.
- FIRE HYDRANTS SHALL BE CITY APPROVED AND COLOR CODED.
- ALL GATE VALVES AND FITTINGS SHALL BE CITY APPROVED.
- MATERIALS AND INSTALLATION FOR ALL PROPOSED UTILITY LINES AND APPURTENANCES SHALL COMPLY WITH THE REQUIREMENTS IN THE SPECIFICATIONS.
- CONTRACTOR SHALL ON ALL WET UTILITIES, COORDINATE INSPECTION WITH APPROPRIATE AUTHORITIES PRIOR TO COVERING TRENCHES AT INSTALLATION. THE CONTRACTOR SHALL CONDUCT ALL REQUIRED TESTS TO THE SATISFACTION OF THE OWNERS INSPECTING AUTHORITIES.
- CONTRACTOR SHALL COORDINATE INSTALLATION OF UTILITIES IN SUCH A MANNER AS TO AVOID CONFLICTS AND ASSURE PROPER DEPTHS ARE ACHIEVED AS WELL AS COORDINATING WITH THE CITY UTILITY DEPARTMENT AS TO LOCATION AND SCHEDULING OF TIE-INS/CONNECTIONS PRIOR TO CONNECTING TO EXISTING UTILITIES.
- DIMENSIONS SHOWN ARE TO CENTER LINE OF PIPE OR FITTING OR TO CENTER OF MANHOLE.
- THE TOP ELEVATION OF MANHOLES CONSTRUCTED IN PAVED AREAS SHALL MATCH FINISHED GRADE. THE TOP ELEVATION OF MANHOLES CONSTRUCTED IN GRASSED AREAS SHALL BE SIX INCHES ABOVE FINISHED GRADE, UNLESS OTHERWISE NOTED.
- CONTRACTOR SHALL GROUT AROUND ALL PIPE ENTRANCES TO SANITARY SEWER MANHOLES WITH NON-SHRINKING GROUT TO ASSURE CONNECTION IS WATERTIGHT.
- CONTRACTOR SHALL RAISE/LOWER OR ADJUST ALL EXISTING UTILITY MAINS IN CONFLICT WITH PROPOSED UTILITIES AS PART OF THE BASE BIDS FOR ALL KNOWN OR UNKNOWN LINES.
- CONTRACTOR SHALL BE RESPONSIBLE FOR COORDINATING THE INSTALLATION OF ALL LINES TO BE INSTALLED BY THE UTILITY COMPANIES.
- IF ROCK IS ENCOUNTERED IN THE TRENCH, ROCK SPOILS SHALL NOT BE USED IN THE TRENCH. THE TRENCH SHALL BE BACKFILLED ONLY WITH QUALITY BACKFILL PER THE TECHNICAL SPECIFICATIONS.
- BACKFILL FOR UTILITY LINES SHALL BE CAREFULLY PLACED SO THAT IT WILL BE STABLE. WHERE UTILITY LINES PASS UNDER PAVED AREAS, THE TOP 6" OF BACKFILL SHALL BE COMPACTED SIMILARLY TO THE REMAINDER OF THE LOT. UTILITY TRENCHES SHALL BE VISIBLY INSPECTED DURING THE EXCAVATION PROCESS TO ENSURE UNDESIRABLE FILL IS NOT USED.
- ALL WATER AND SEWER TAPS, AND METERS (LESS THAN 3 INCHES) SHALL BE INSTALLED BY THE CITY OF TYLER AT THE CONTRACTOR'S EXPENSE. CALL ENGINEERING PLAN REVIEW AT (903) 531-1171 FOR COST AND COORDINATION.

### PAVING / DRAINAGE NOTES:

- NO EARTH-DISTURBING ACTIVITIES SHALL COMMENCE UNTIL ALL PERMITS HAVE BEEN OBTAINED AND PERIMETER EROSION CONTROL MEASURES HAVE BEEN INSTALLED. THE CONTRACTOR SHALL ADHERE TO ALL TERMS & CONDITIONS AS OUTLINED IN THE GENERAL T.P.D.E.S. PERMIT FOR STORM WATER DISCHARGES ASSOCIATED WITH CONSTRUCTION ACTIVITY.
- CONTRACTOR SHALL NOTIFY ALL UTILITY COMPANIES HAVING UNDERGROUND UTILITIES ON SITE OR IN RIGHT-OF-WAY PRIOR TO EXCAVATION. CONTRACTOR SHALL CONTACT UTILITY LOCATING COMPANY AND LOCATE ALL UTILITIES PRIOR TO GRADING START.
- CONTRACTOR SHALL VERIFY HORIZONTAL AND VERTICAL LOCATION OF ALL EXISTING STORM SEWER STRUCTURES, PIPES, AND ALL UTILITIES PRIOR TO CONSTRUCTION.
- ALL PIPES ENTERING STORM SEWER STRUCTURES SHALL BE GROUTED WITH NON-SHRINK GROUT TO ASSURE A WATER-TIGHT FIT.
- ALL DRAINAGE STRUCTURES AND STORM SEWER PIPES LOCATED IN PAVED OR OTHER VEHICULAR AREAS SHALL MEET HEAVY DUTY TRAFFIC (H20) LOADING AND BE INSTALLED ACCORDINGLY.
- ACCESSIBLE ROUTES SHALL HAVE A RUNNING SLOPE OF MAX. 5.0% AND CROSS SLOPE OF MAX. 2.0%, PER TAS REQUIREMENTS.
- RIPRAP GRADATION SHALL BE IN ACCORDANCE WITH THE SITESWORK SPECIFICATIONS & DETAILS.
- IF THE CONTRACTOR RELOCATES BENCHMARK WITH A NEW BENCHMARK, IT SHALL BE LOCATED WITHIN A TOLERANCE OF 0.010 FEET.
- CONTRACTOR SHALL MATCH EXISTING PAVEMENT IN GRADE AND ALIGNMENT, WHERE APPLICABLE.
- CONTRACTOR SHALL MATCH EXISTING CURB AND GUTTER IN GRADE, SIZE, TYPE AND ALIGNMENT AT ADJACENT ROADWAYS.
- ADJUST PAVEMENT AND/OR CURB ELEVATIONS AS NECESSARY TO ASSURE A SMOOTH FIT AND CONTINUOUS GRADE WITH EXISTING, WHERE APPLICABLE.
- DRAINAGE SHALL BE MAINTAINED AWAY FROM FOUNDATIONS, BOTH DURING AND AFTER CONSTRUCTION.
- ALL EARTHWORK AND PAVING OPERATIONS SHALL CONFORM TO THE RECOMMENDATIONS PER THE GEOTECHNICAL REPORT (PROJECT #CM225107) BY TERRACON, INC. DATED 10/10/2022.
- ALL PROPOSED CONTOURS AND SPOT GRADES ARE FOR THE FINISHED SURFACE. CONTRACTOR SHALL ADJUST ROUGH GRADING AS NEEDED TO ACCOUNT FOR IMPORT MATERIALS.
- ALL PAVING AND DRAINAGE IMPROVEMENTS SHALL BE DESIGNED AND CONSTRUCTED IN ACCORDANCE WITH CITY STANDARD SPECIFICATIONS. WHERE ANY QUESTIONS ARISE AS TO THE INTERPRETATION OF THE STANDARDS OF DESIGN, PLEASE CONTACT THE CONSULTANT.
- FIRE LANES SHALL MEET FIRE CODE REQUIREMENTS.



### LANDSCAPE / IRRIGATION NOTES:

- ALL IMPROVEMENTS SHALL BE IN ACCORDANCE WITH THE CITY SPECIFICATIONS AND ORDINANCES.
- THE CONTRACTOR IS REQUIRED TO GRASS ALL AREAS DISTURBED BY CONSTRUCTION.
- AT COMPLETION OF THE PAVING AND FINAL GRADING, THE DISTURBED AREA(S) SHALL BE REVEGETATED IN ACCORDANCE WITH THE PLANS.
- ALL PROPOSED PLANTS SHALL BE STAKED ON THE GROUND AND APPROVED BY CONSULTANT BEFORE BEING PLANTED.
- ALL PLANTING BEDS SHALL HAVE 4 INCH DEEP HARDWOOD MULCH.
- ALL LAWN AREAS SHALL BE SPRAYED WITH HERBICIDE, CROSS DISCED AND DRAGGED UNTIL SMOOTH PRIOR TO SEEDING.
- IRRIGATION SYSTEM IS BASED ON ASSUMED PSI AT THE PROPOSED BACKFLOW. CONTRACTOR SHALL VERIFY THAT ADEQUATE PSI IS AVAILABLE AFTER METER IS INSTALLED AND NOTIFY CONSULTANT IF IT ISN'T.
- SPRINKLER AND VALVE LOCATIONS ARE TO SCALE. PIPE LOCATIONS ARE DIAGRAMMATIC.
- ALL SPRINKLER HEADS SHALL BE SET PERPENDICULAR TO FINISHED GRADE UNLESS OTHERWISE SPECIFIED.
- COORDINATE ALL MAINLINE AND LATERAL PIPE INSTALLATION LOCATIONS WITH ELECTRICAL PLANS AND ADJUST AS NECESSARY.
- IRRIGATION CONTROLLERS ARE TO BE PLACED IN THE LOCATIONS SHOWN ON THE PLANS. COORDINATE W/ ELECTRICAL DRAWINGS FOR CONTROLLER LOCATION & POWER SOURCE LOCATION.
- EXCEPT AS OTHERWISE PROVIDED, THE CONTRACTOR SHALL PROCURE ALL PERMITS AND LICENSES, PAY ALL CHARGES AND FEES AND GIVE ALL NOTICES NECESSARY & INCIDENTAL TO THE DUE LAWFUL PROSECUTION OF THE WORK.
- CONTRACTOR SHALL NOTIFY PERTINENT UTILITY COMPANIES 48 HOURS PRIOR TO CONSTRUCTION FOR CURRENT UTILITY LOCATIONS. EXTREME CARE SHALL BE EXERCISED IN EXCAVATING AND WORKING NEAR EXISTING UTILITIES. CONTRACTOR SHALL VERIFY THE LOCATION & CONDITION OF ALL UTILITIES AND BE RESPONSIBLE FOR DAMAGE TO ANY UTILITIES.
- THE CONTRACTOR SHALL AT ALL TIMES PROTECT HIS WORK FROM DAMAGE & THEFT & REPLACE ALL DAMAGED OR STOLEN PARTS UNTIL THE WORK IS ACCEPTED IN WRITING BY OWNER.
- THE CONTRACTOR SHALL NOT WILLFULLY INSTALL THE SPRINKLER AS SHOWN ON THE DRAWINGS WHEN IT IS OBVIOUS IN THE FIELD THAT OBSTRUCTIONS, GRADE DIFFERENCES, OR DIFFERENCES IN THE AREAS DIMENSIONS EXIST THAT MIGHT NOT HAVE BEEN CONSIDERED IN THE DESIGN. SUCH OBSTRUCTIONS OR DIFFERENCES SHALL BE BROUGHT TO THE ATTENTION OF THE OWNER. IN THE EVENT THIS NOTIFICATION IS NOT PERFORMED, THE IRRIGATION CONTRACTOR SHALL ASSUME FULL RESPONSIBILITY FOR ANY REVISIONS NECESSARY.
- ALL PIPES UNDER WALKWAYS AND DRIVEWAYS SHALL BE SLEEVED.



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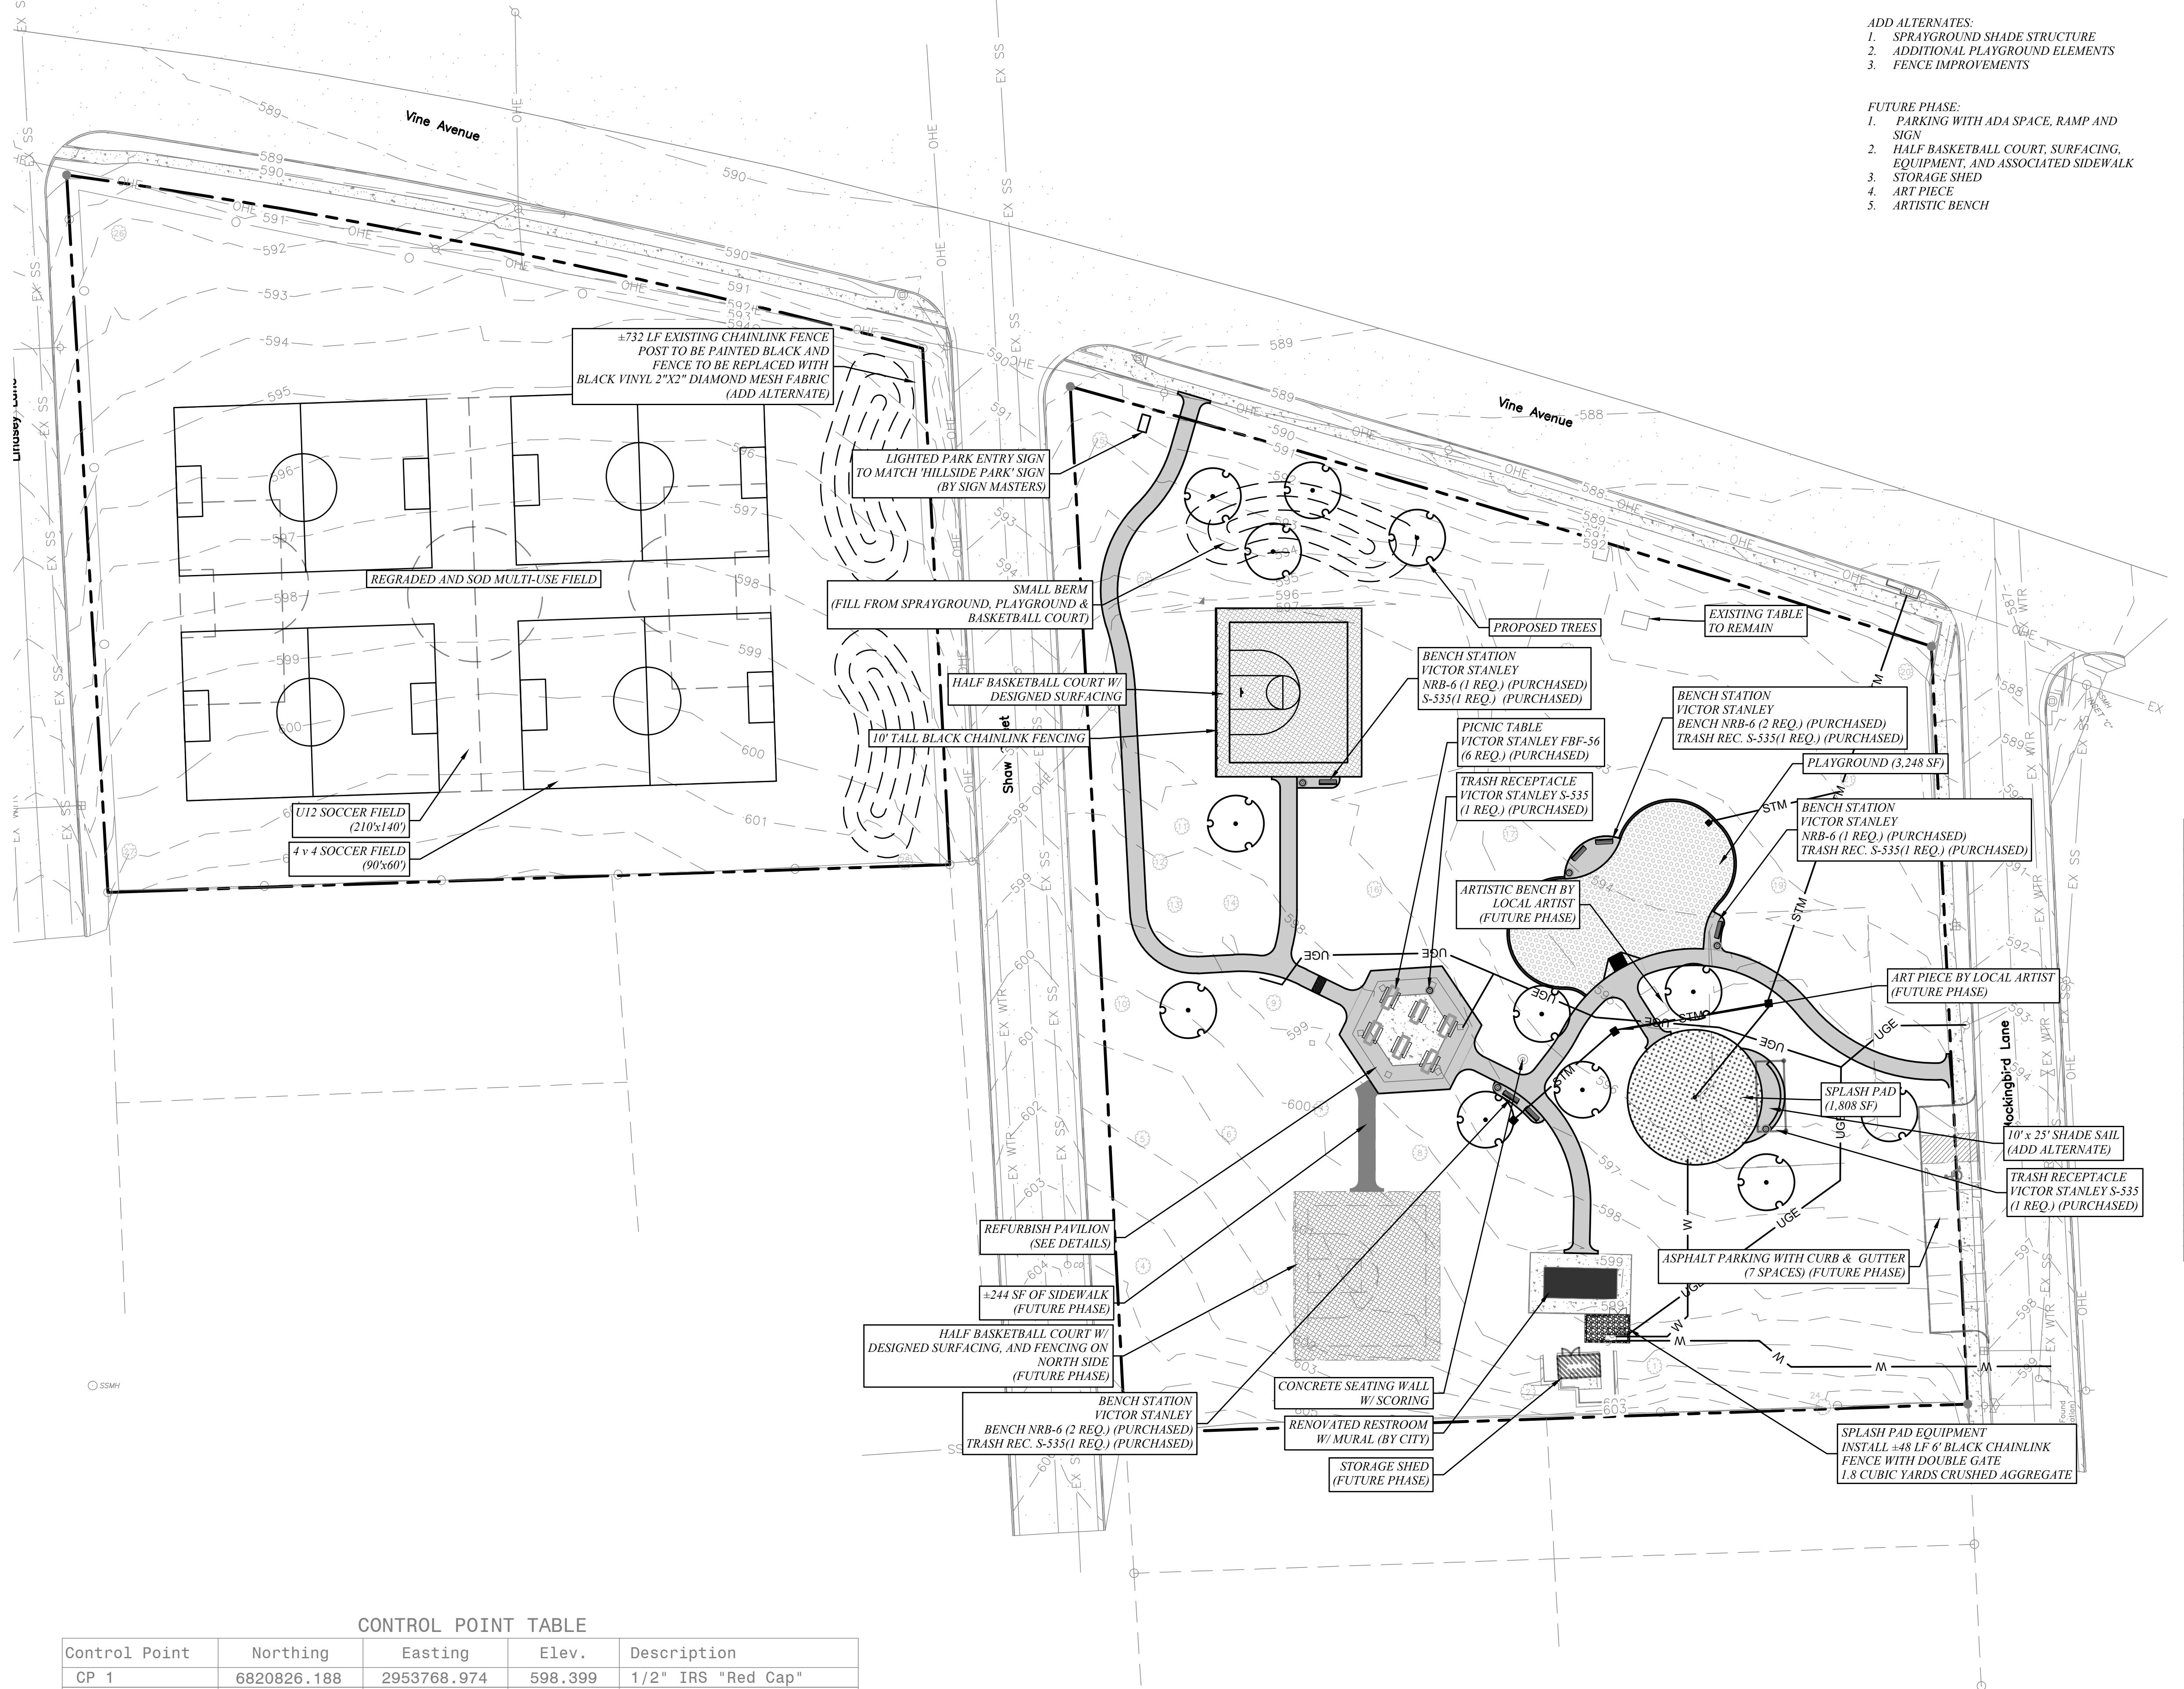
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**MHS**  
PLANNING & DESIGN, LLC  
212 West Ninth Street, Tyler, Texas 75701  
903.597.6606

## SITE PLAN

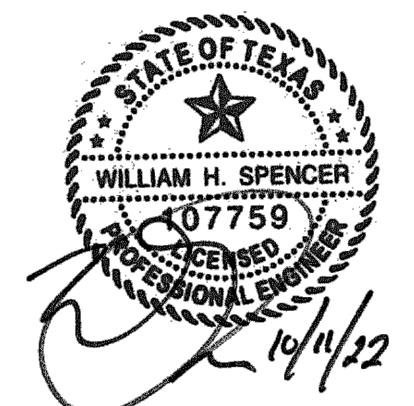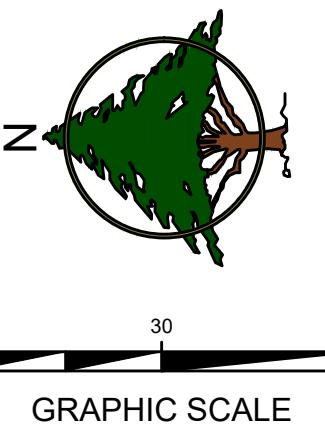P.T. COLE PARK  
CITY OF TYLER, TEXAS



LEGEND	
PROPERTY LINE	
WATER LINE	
SSANITARY SEWER PIPE	
STMSTORM SEWER PIPE	
OHEOVERHEAD ELECTRIC	
UGEUNDERGROUND ELECTRIC & TELECOMMUNICATION	
6" ASPHALT PAVEMENT	
4" CONCRETE SIDEWALK	
PLAYGROUND	
SPRAYGROUND	
BASKETBALL COURT	
EXISTING TREES	

Point	Size	Type
1	24"	Live Oak
2	36"	Post Oak
3	8"	Red Bud
4	54"	Water Oak
5	10"	Chinese Pistache
6	18"	Sycamore
7	20"	Sycamore
8	18"	Chinquapin Oak
9	26"	Sycamore
10	15"	Pin Oak
11	24"	Water Oak
12	15"	Water Oak
13	15"	Water Oak
14	18"	Pin Oak
15	48"	Pin Oak
16	14"	Burch
17	12"	Chinese Pistache
18	50"	Live Oak
19	10"	Chinese Pistache
20	12"	Pecan
21	8"	Chinese Pistache
22	14"	Pecan
23	38"	Pin Oak
24	36"	Water Oak
25	10"	Chinese Pistache
26	42"	Water Oak
27	16"	Water Oak
28	42"	Hackberry

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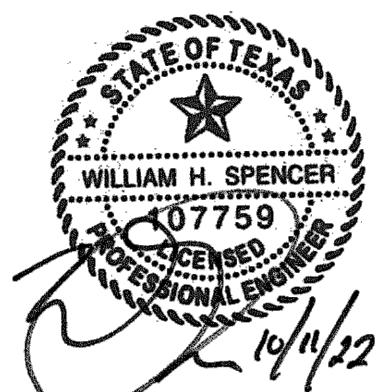


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C3

### CONTROL POINT TABLE

Control Point	Northing	Easting	Elev.	Description
CP 1	6820826.188	2953768.974	598.399	1/2" IRS "Red Cap"
CP 5	6820835.552	2954073.795	587.416	1/2" IRS "Red Cap"
CP 9A	6820117.314	2953758.925	590.712	1/2" IRS "Red Cap"
CP 10A	6820478.568	2954004.487	589.279	1/2" IRS "Red Cap"
CP 11A	6820466.498	2953576.626	604.476	1/2" IRS "Red Cap"
CP 12A	6820108.670	2953572.794	598.366	1/2" IRS "Red Cap"
COT BM # T-090	6820485.929	2953904.593	591.037	City of Tyler Benchmark



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112 West Ninth Street Tyler, Texas 75701  
03-597-6606 TBPE No. 14571


# DEMOLITION PLAN

# P.T. COLE PARK CITY OF TYLER, TEXAS

WN: **MEP**  
CKED: **WHS**  
E: **10/11/2022**  
LE: **AS SHOWN**  
NO.: **22-069**

Know what's below.  
**Call before you dig.**

C4

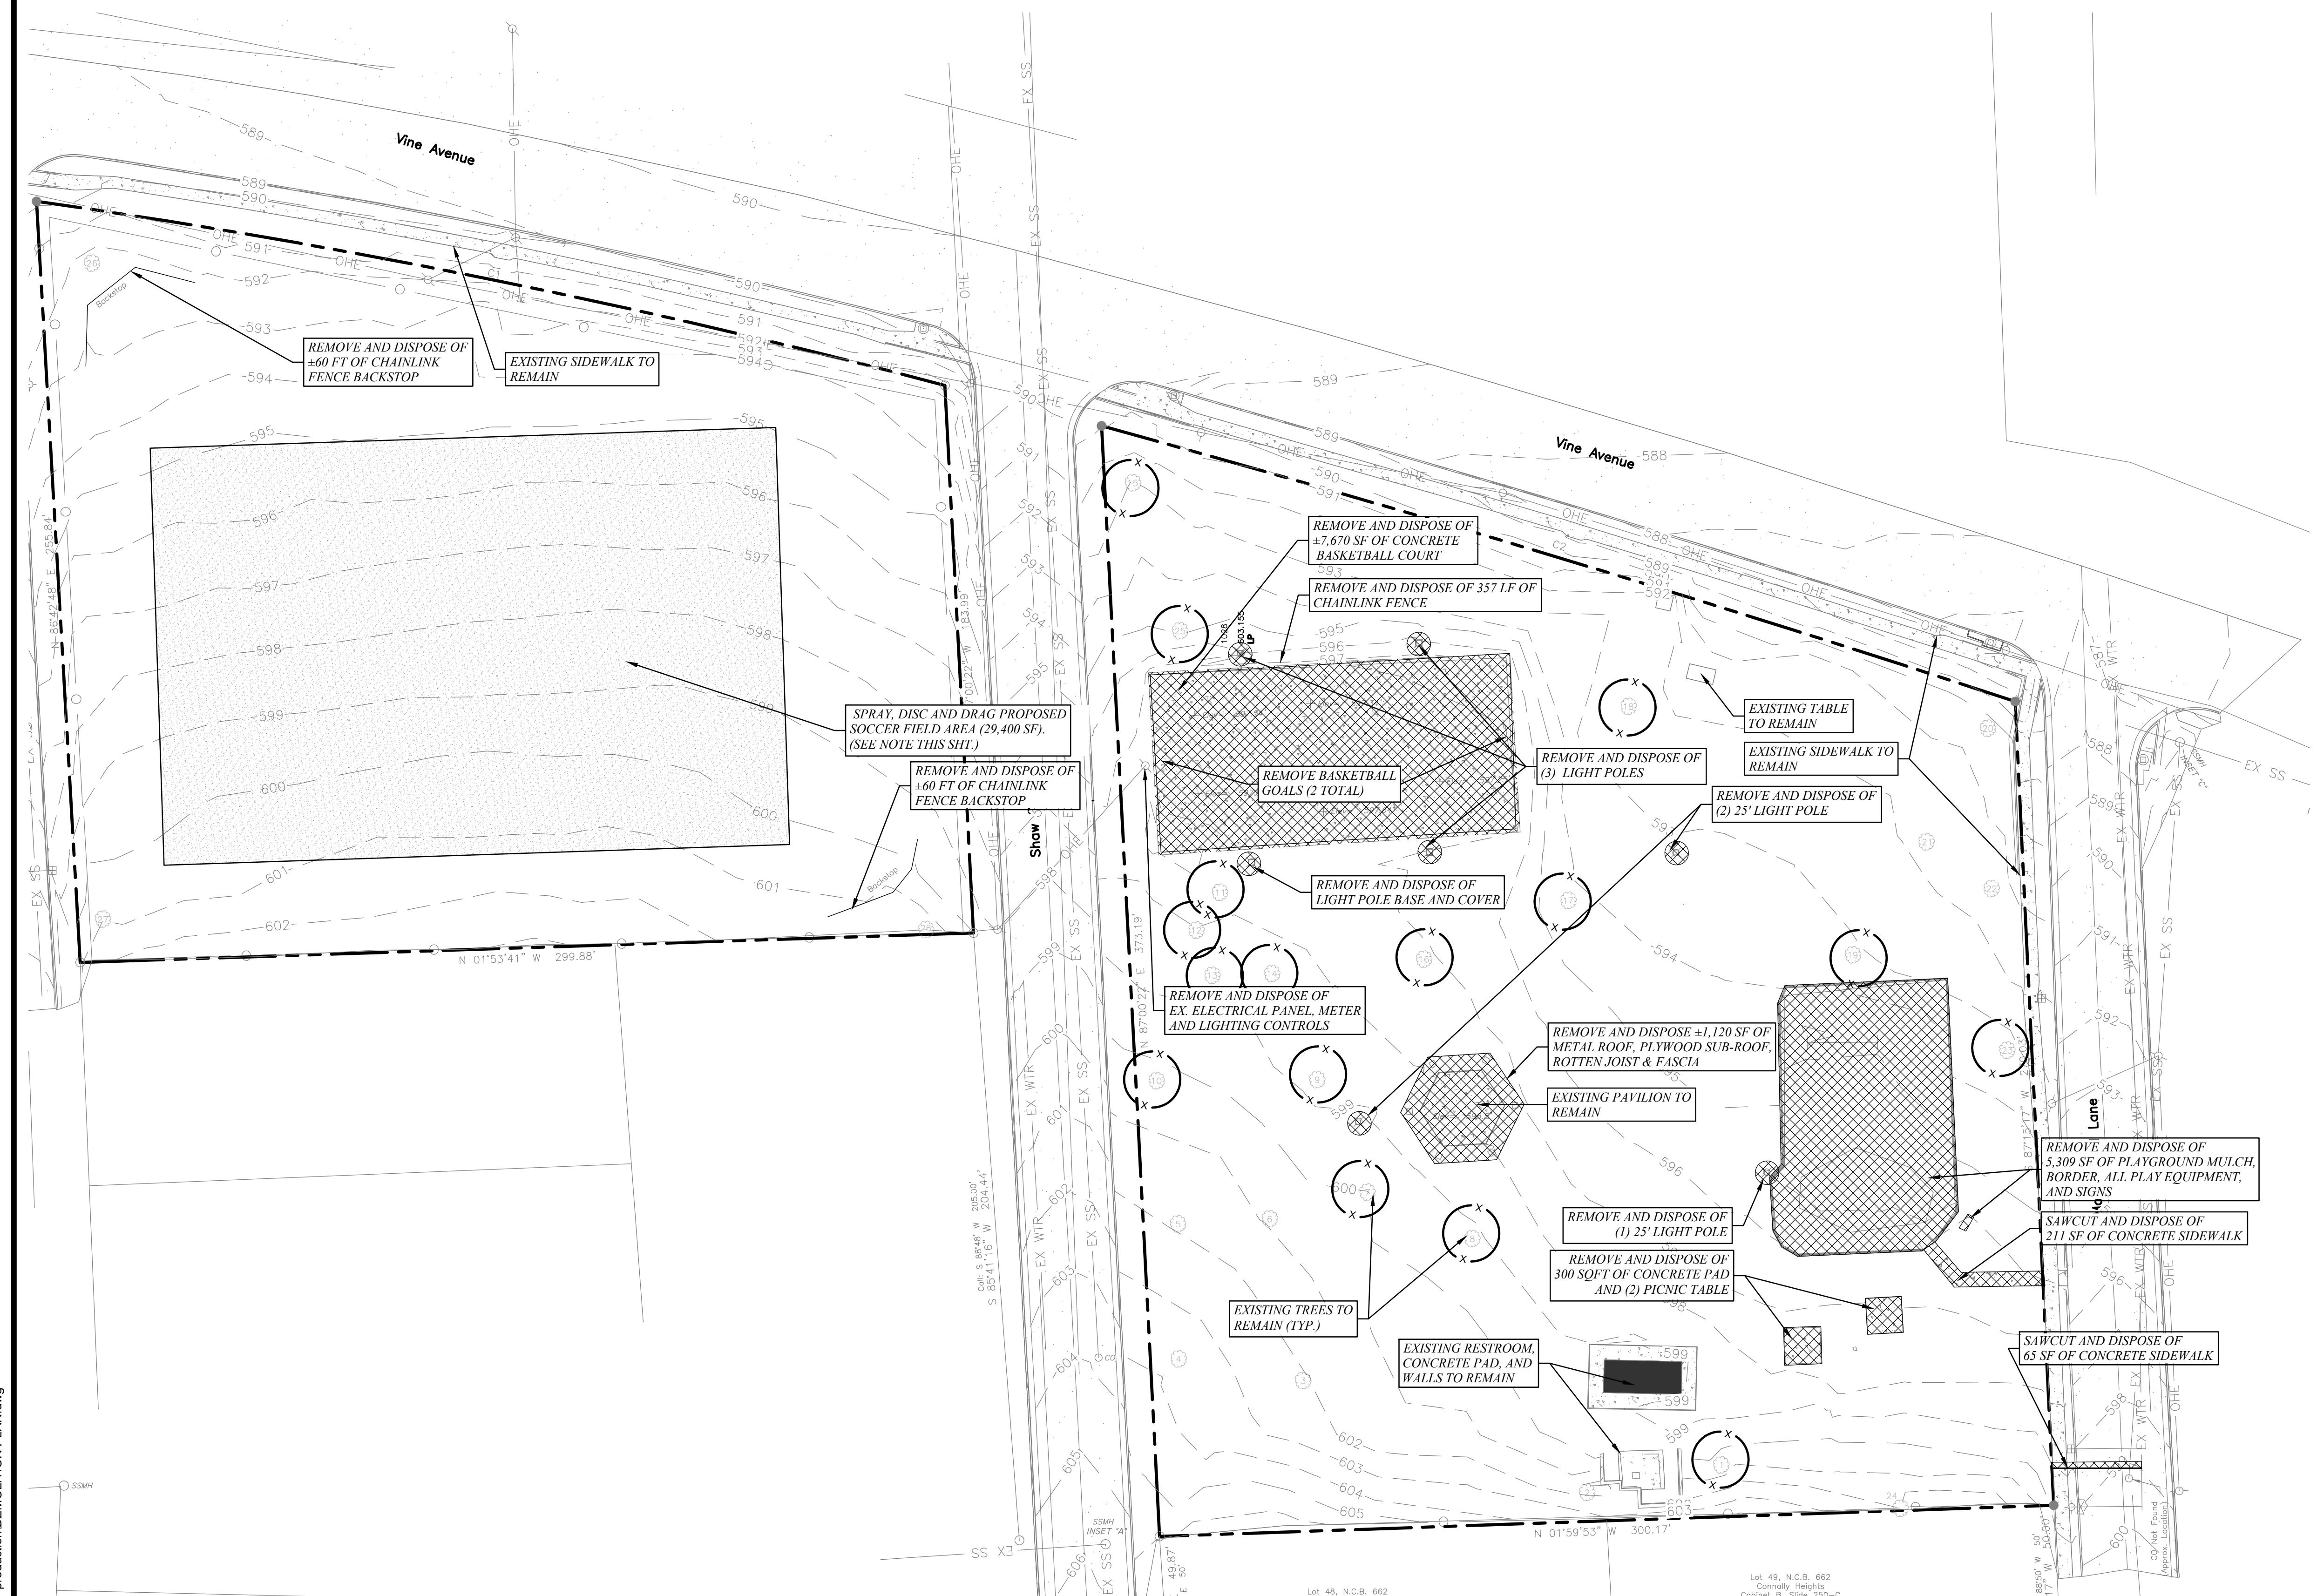

## TREE TABLE

Point	Size	Type
1	24"	Live Oak
2	36"	Post Oak
3	8"	Red Bud
4	54"	Water Oak
5	10"	Chinese Pistache
6	18"	Sycamore
7	20"	Sycamore
8	18"	Chinquapin Oak
9	26"	Sycamore
10	15"	Pin Oak
11	24"	Water Oak
12	15"	Water Oak
13	15"	Water Oak
14	18"	Pin Oak
15	48"	Pin Oak
16	14"	Burch
17	12"	Chinese Pistache
18	50"	Live Oak
19	10"	Chinese Pistache
20	12"	Pecan
21	8"	Chinese Pistache
22	14"	Pecan
23	38"	Pin Oak
24	36"	Water Oak
25	10"	Chinese Pistache
26	42"	Water Oak
27	15"	Water Oak
28	42"	Hackberry


## *FOOTBALL FIELD NOTES:*



**STEP 1 - SPRAY PROPOSED FIELD AREA WITH HERBICIDE  
(ROUNDUP OR APPROVED EQUAL)**

STEP 2 - DISC AND DRAG THE PROPOSED FIELD AREA (6" DEPTH)

### STEP 3 - GRADE SOCCER FIELD (SEE GRADING PLAN)

L:\city of tyler\22-069 pt cole (coft)\CAD\03 - production\DEMOLITION PLAN.dwg

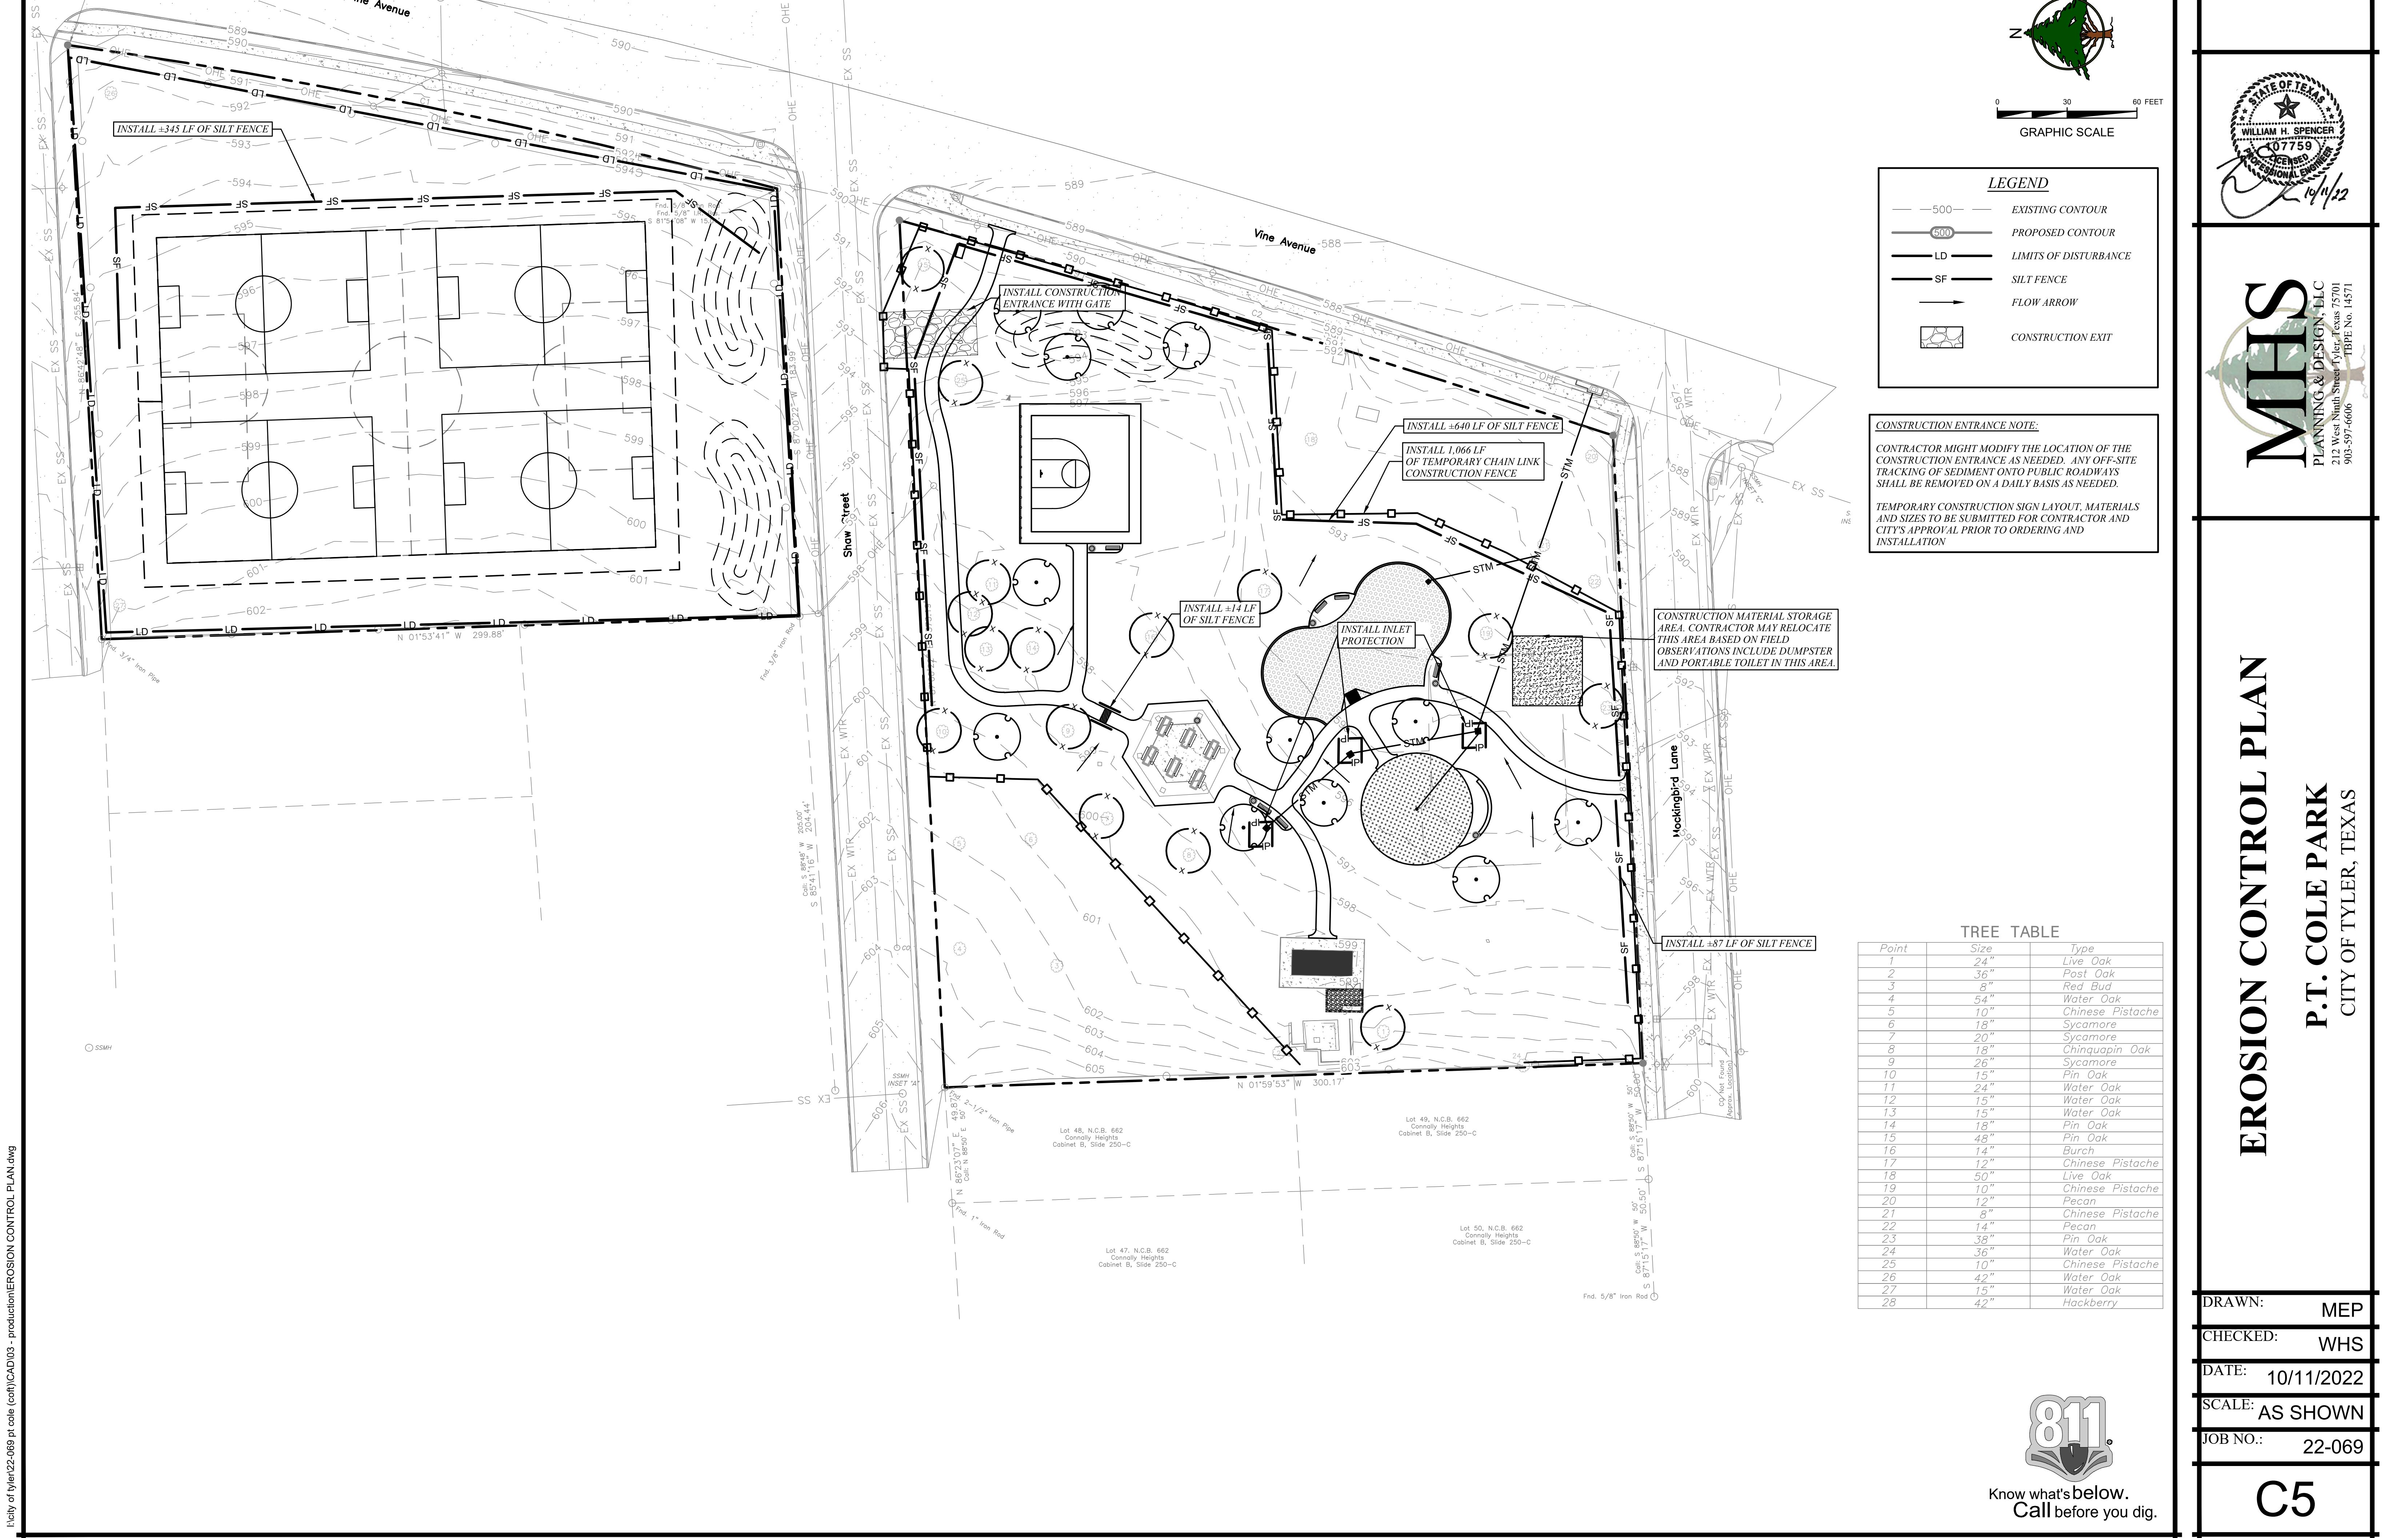

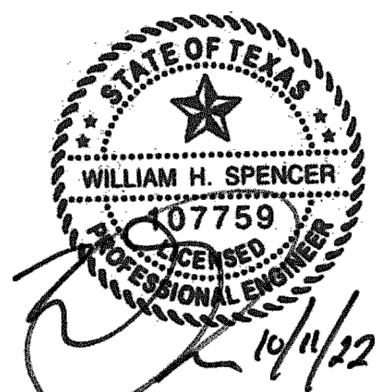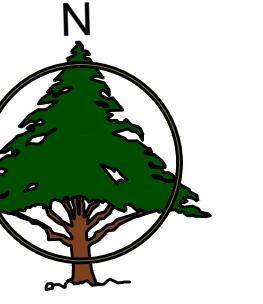

# GRADING PLAN I


# P.T. COLE PARK


## CITY OF TYLER, TEXAS

N: NSF  
KED: WHS  
E: AS SHOWN  
O.: 22-069

Know what's below.  
**Call** before you dig.


C6

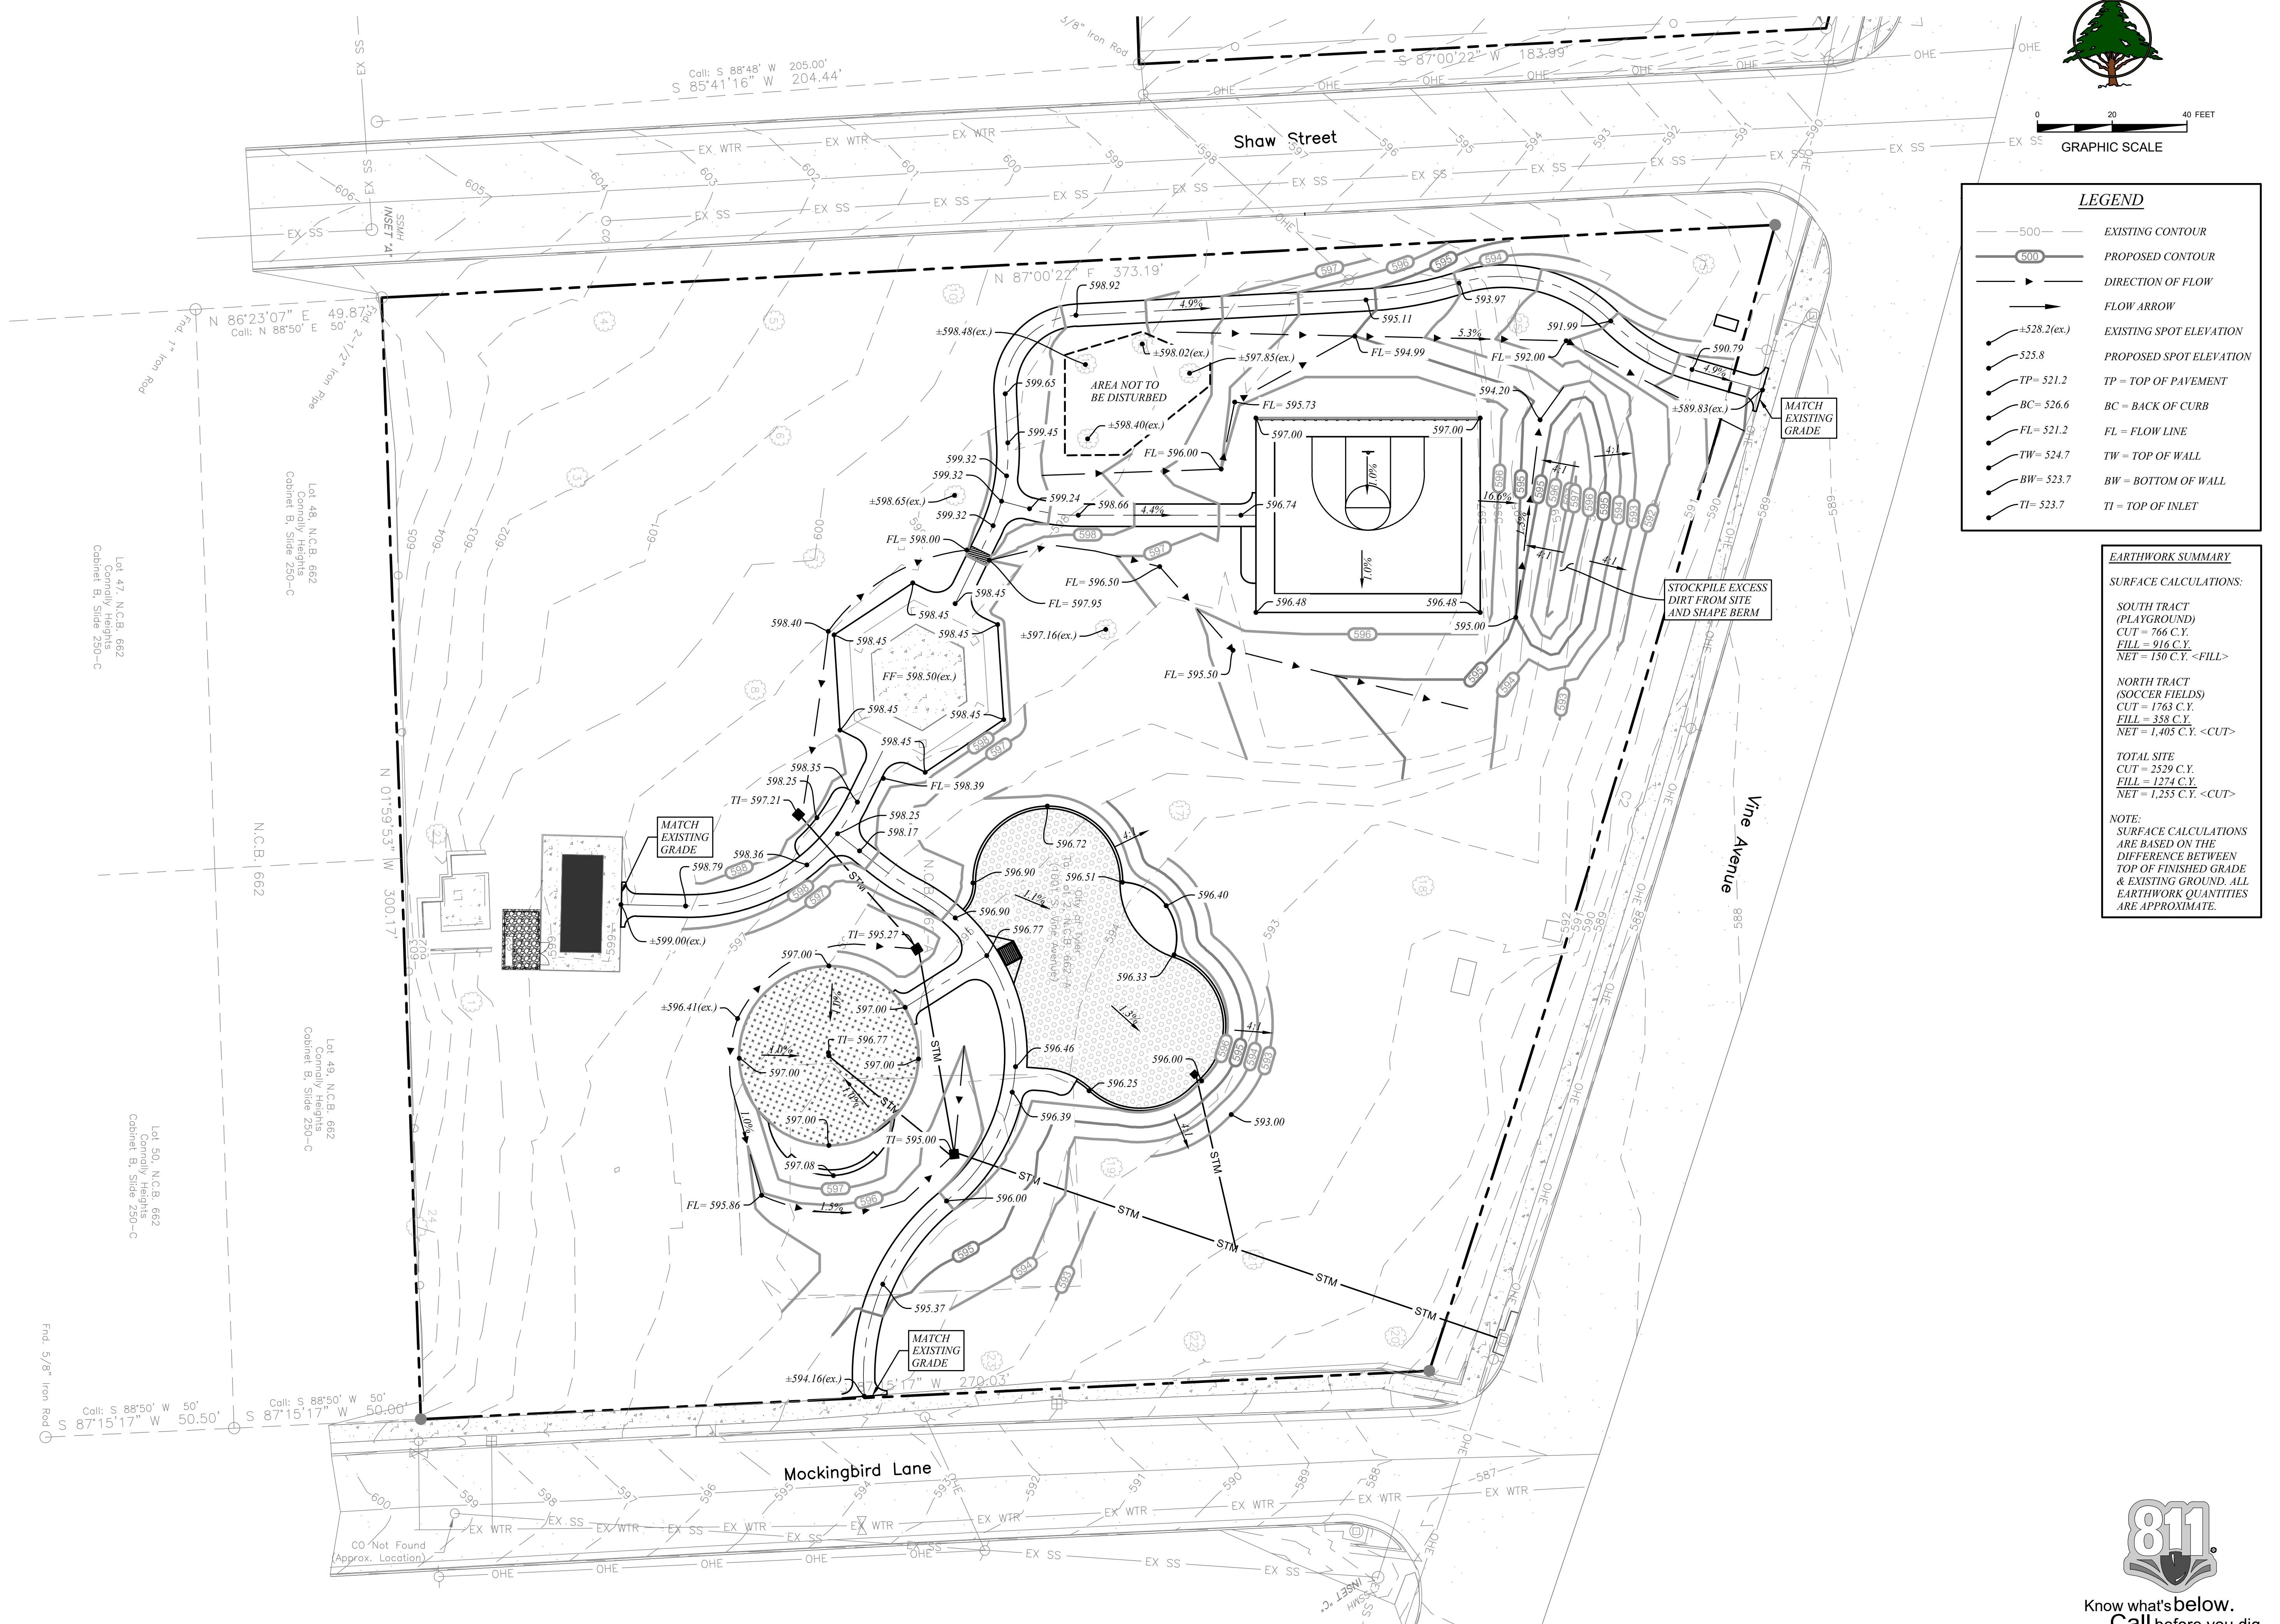

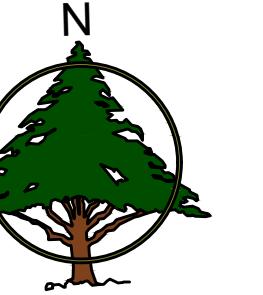

20 40 FEET

GRAPHIC SCALE

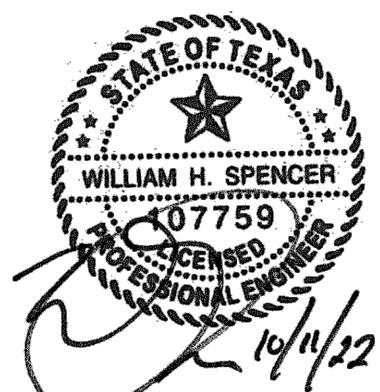

The logo for MHS Planning & Design, LLC. It features a circular emblem with a globe graphic. The letters 'MHS' are prominently displayed in a large, bold, black font across the center of the globe. To the right of the globe, the company name 'PLANNING & DESIGN, LLC' is written vertically in a black serif font. Below the globe, the address '212 West Ninth Street Tyler, Texas 75701' and the phone number '903-597-6606' are listed. To the far right, the text 'TBPE No 14571' is visible.


# P.T. COLE PARK

## CITY OF TYLER TEXAS

NS  
WH  
/11/202  
SHOW  
22-06

C7

now what's below.  
**Call** before you dig.

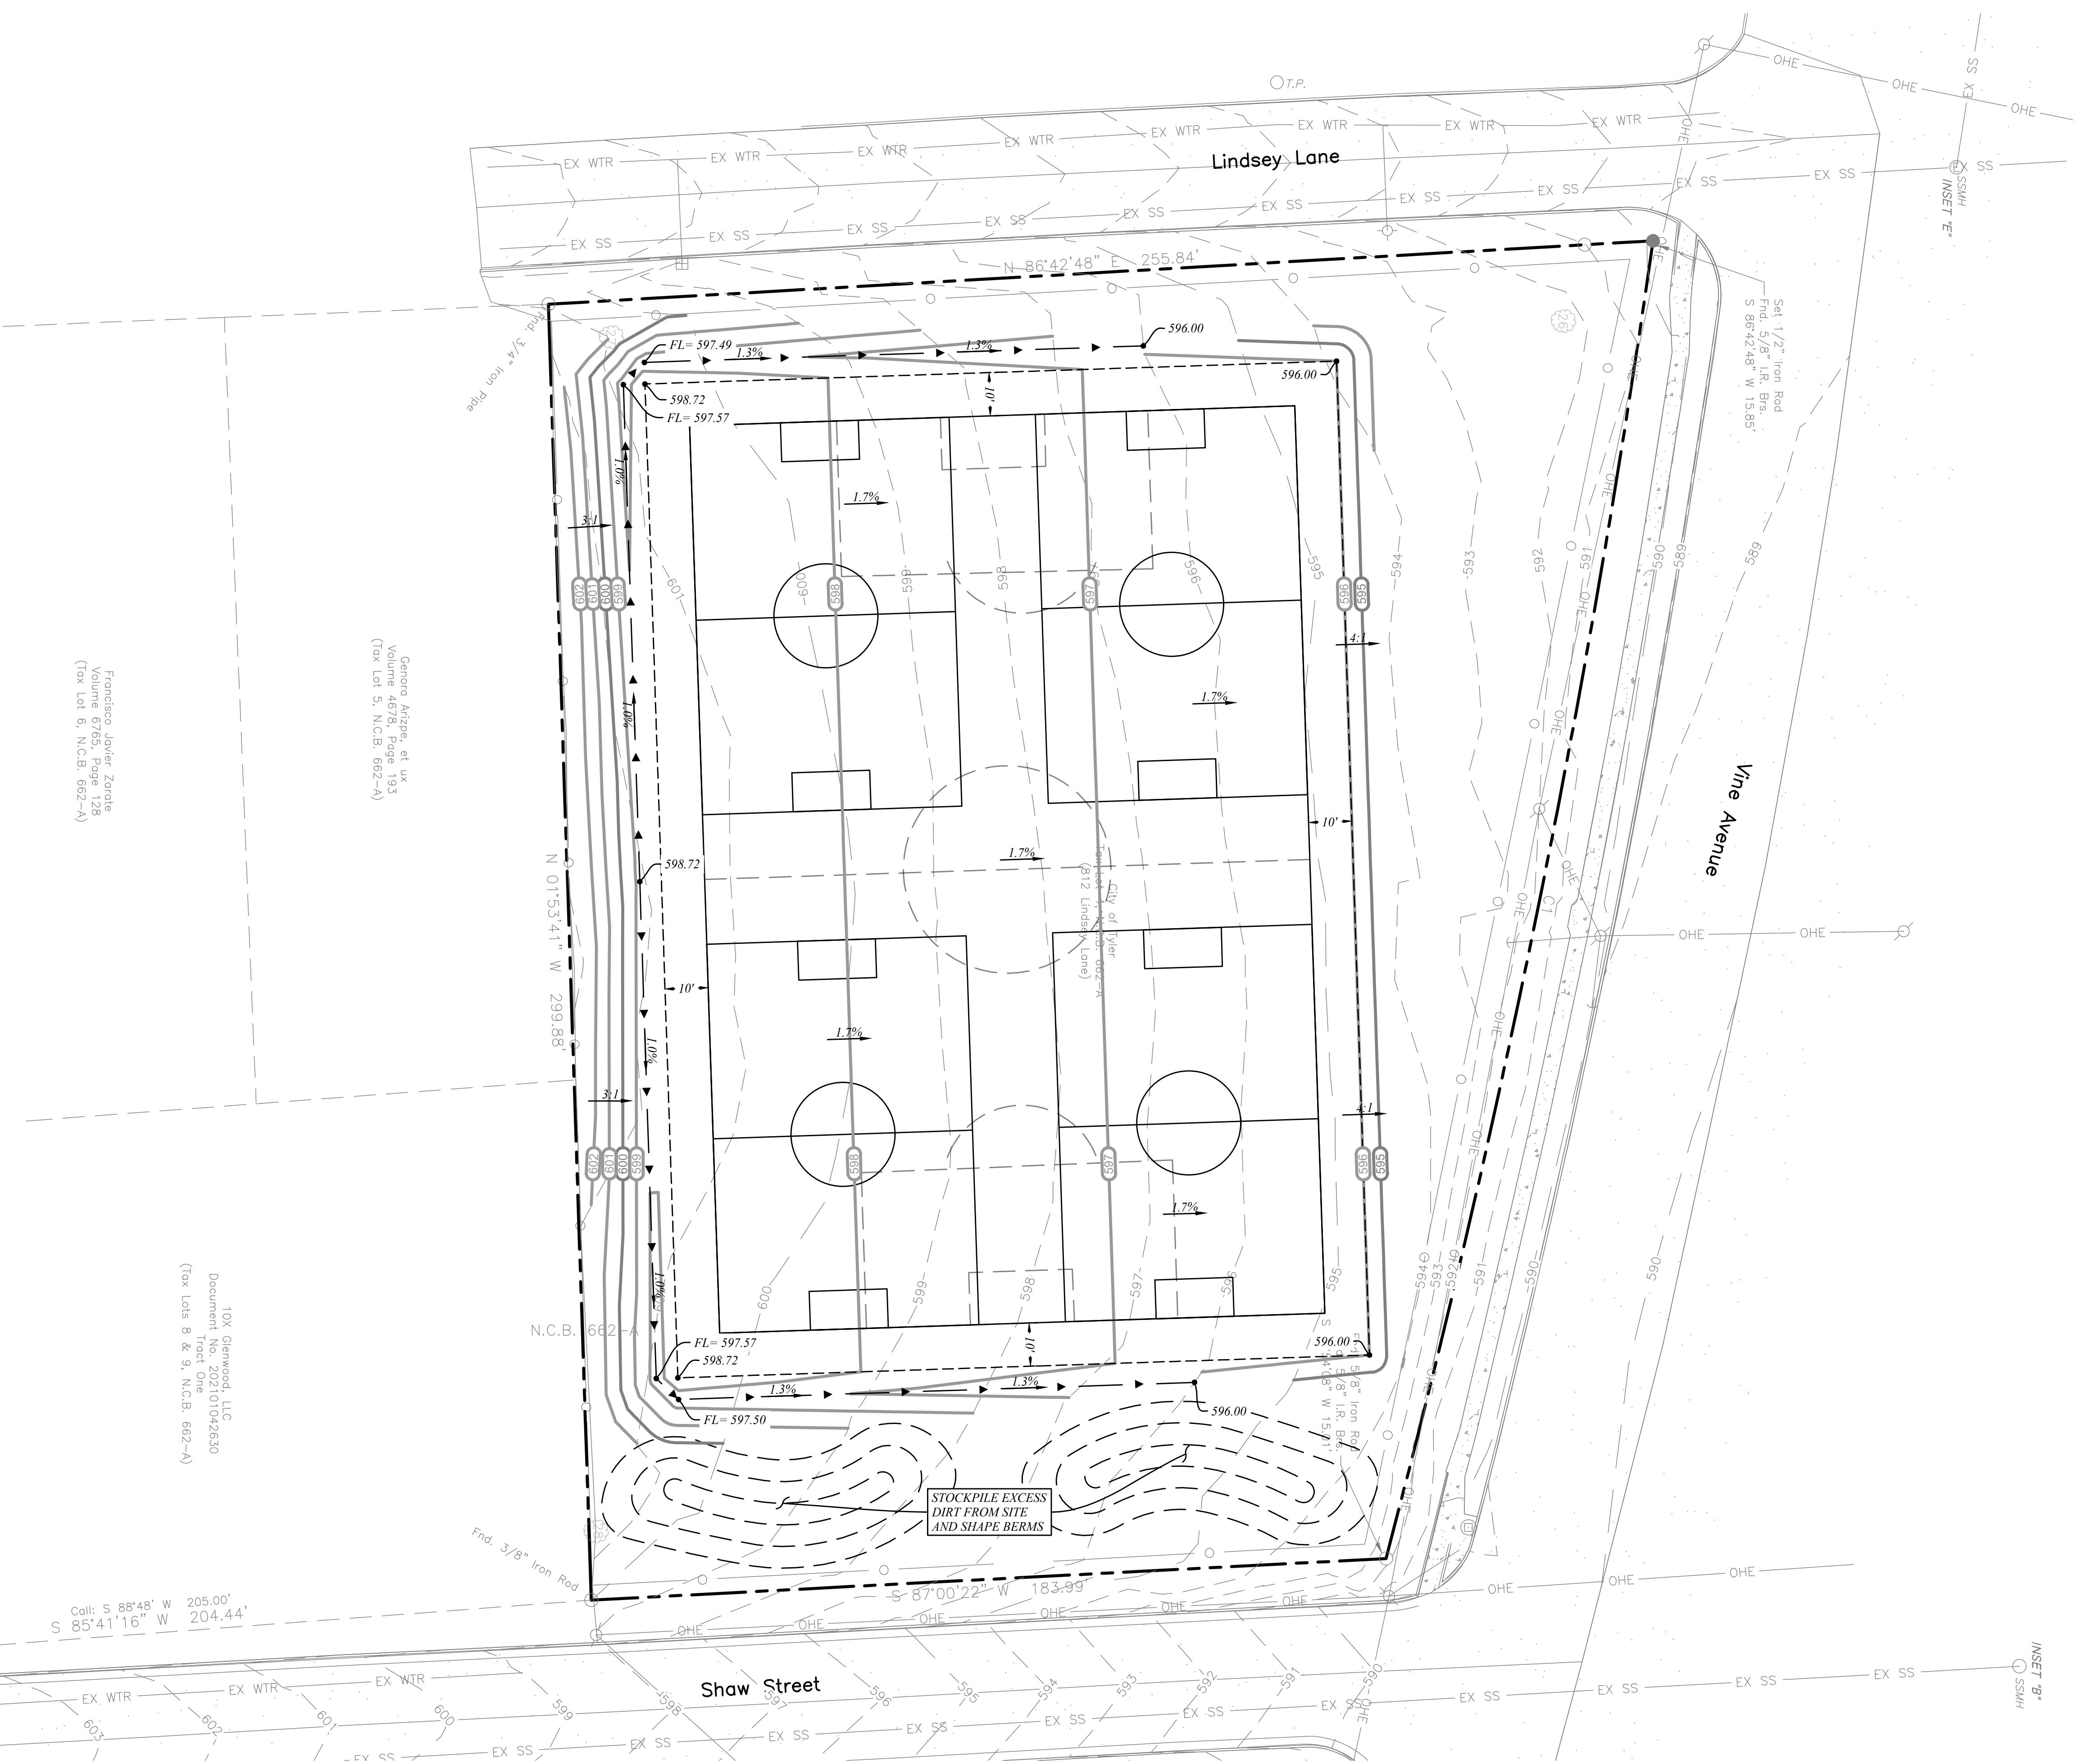



I:\city of tyler\22-069 pt cole (soft)\CAD\03 - production\GRADING PLAN.dwg

Francisco Javier Zarate  
Volume 6765, Page 128  
(Tax lot 6, N.C.B. 662-A)


Genora Arizpe, et ux  
Volume 4678, Page 193  
(Tax Lot 5, N.C.B. 662-A)


10X Glenwood, LLC  
Document No. 202101042630  
Tract One  
(Tax Lots 8 & 9, N.C.B. 662-A)

Francisco Javier Zárate  
Volume 6765, Page 128  
(Tax Lot 6, N.C.B. 662-A))

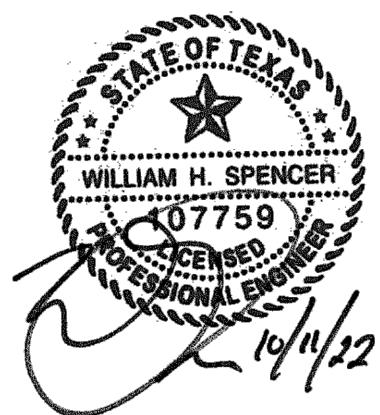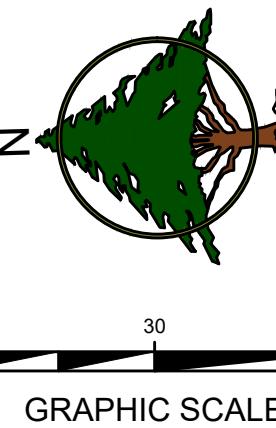

DRAINAGE AREA CALCULATIONS								
DRAINAGE AREA NO.	ACRES DRAINED			TOTAL AREA (AC.)	WEIGHTED RUNOFF COEFFICIENT	TIME OF CONCENTRATION (MIN)	I(100) (IN/HR)	
	OPEN C = 0.35	<1 ACRE LOTS C = 0.50	PAVEMENT C = 0.90					
PRE-A	1.75			1.75	0.35	10	8.82	5.40
PRE-B	1.71			1.92	0.41	10	8.82	6.95
OS1		0.14		0.14	0.50	10	8.82	0.62
OS2		0.14		0.14	0.50	10	8.82	0.62

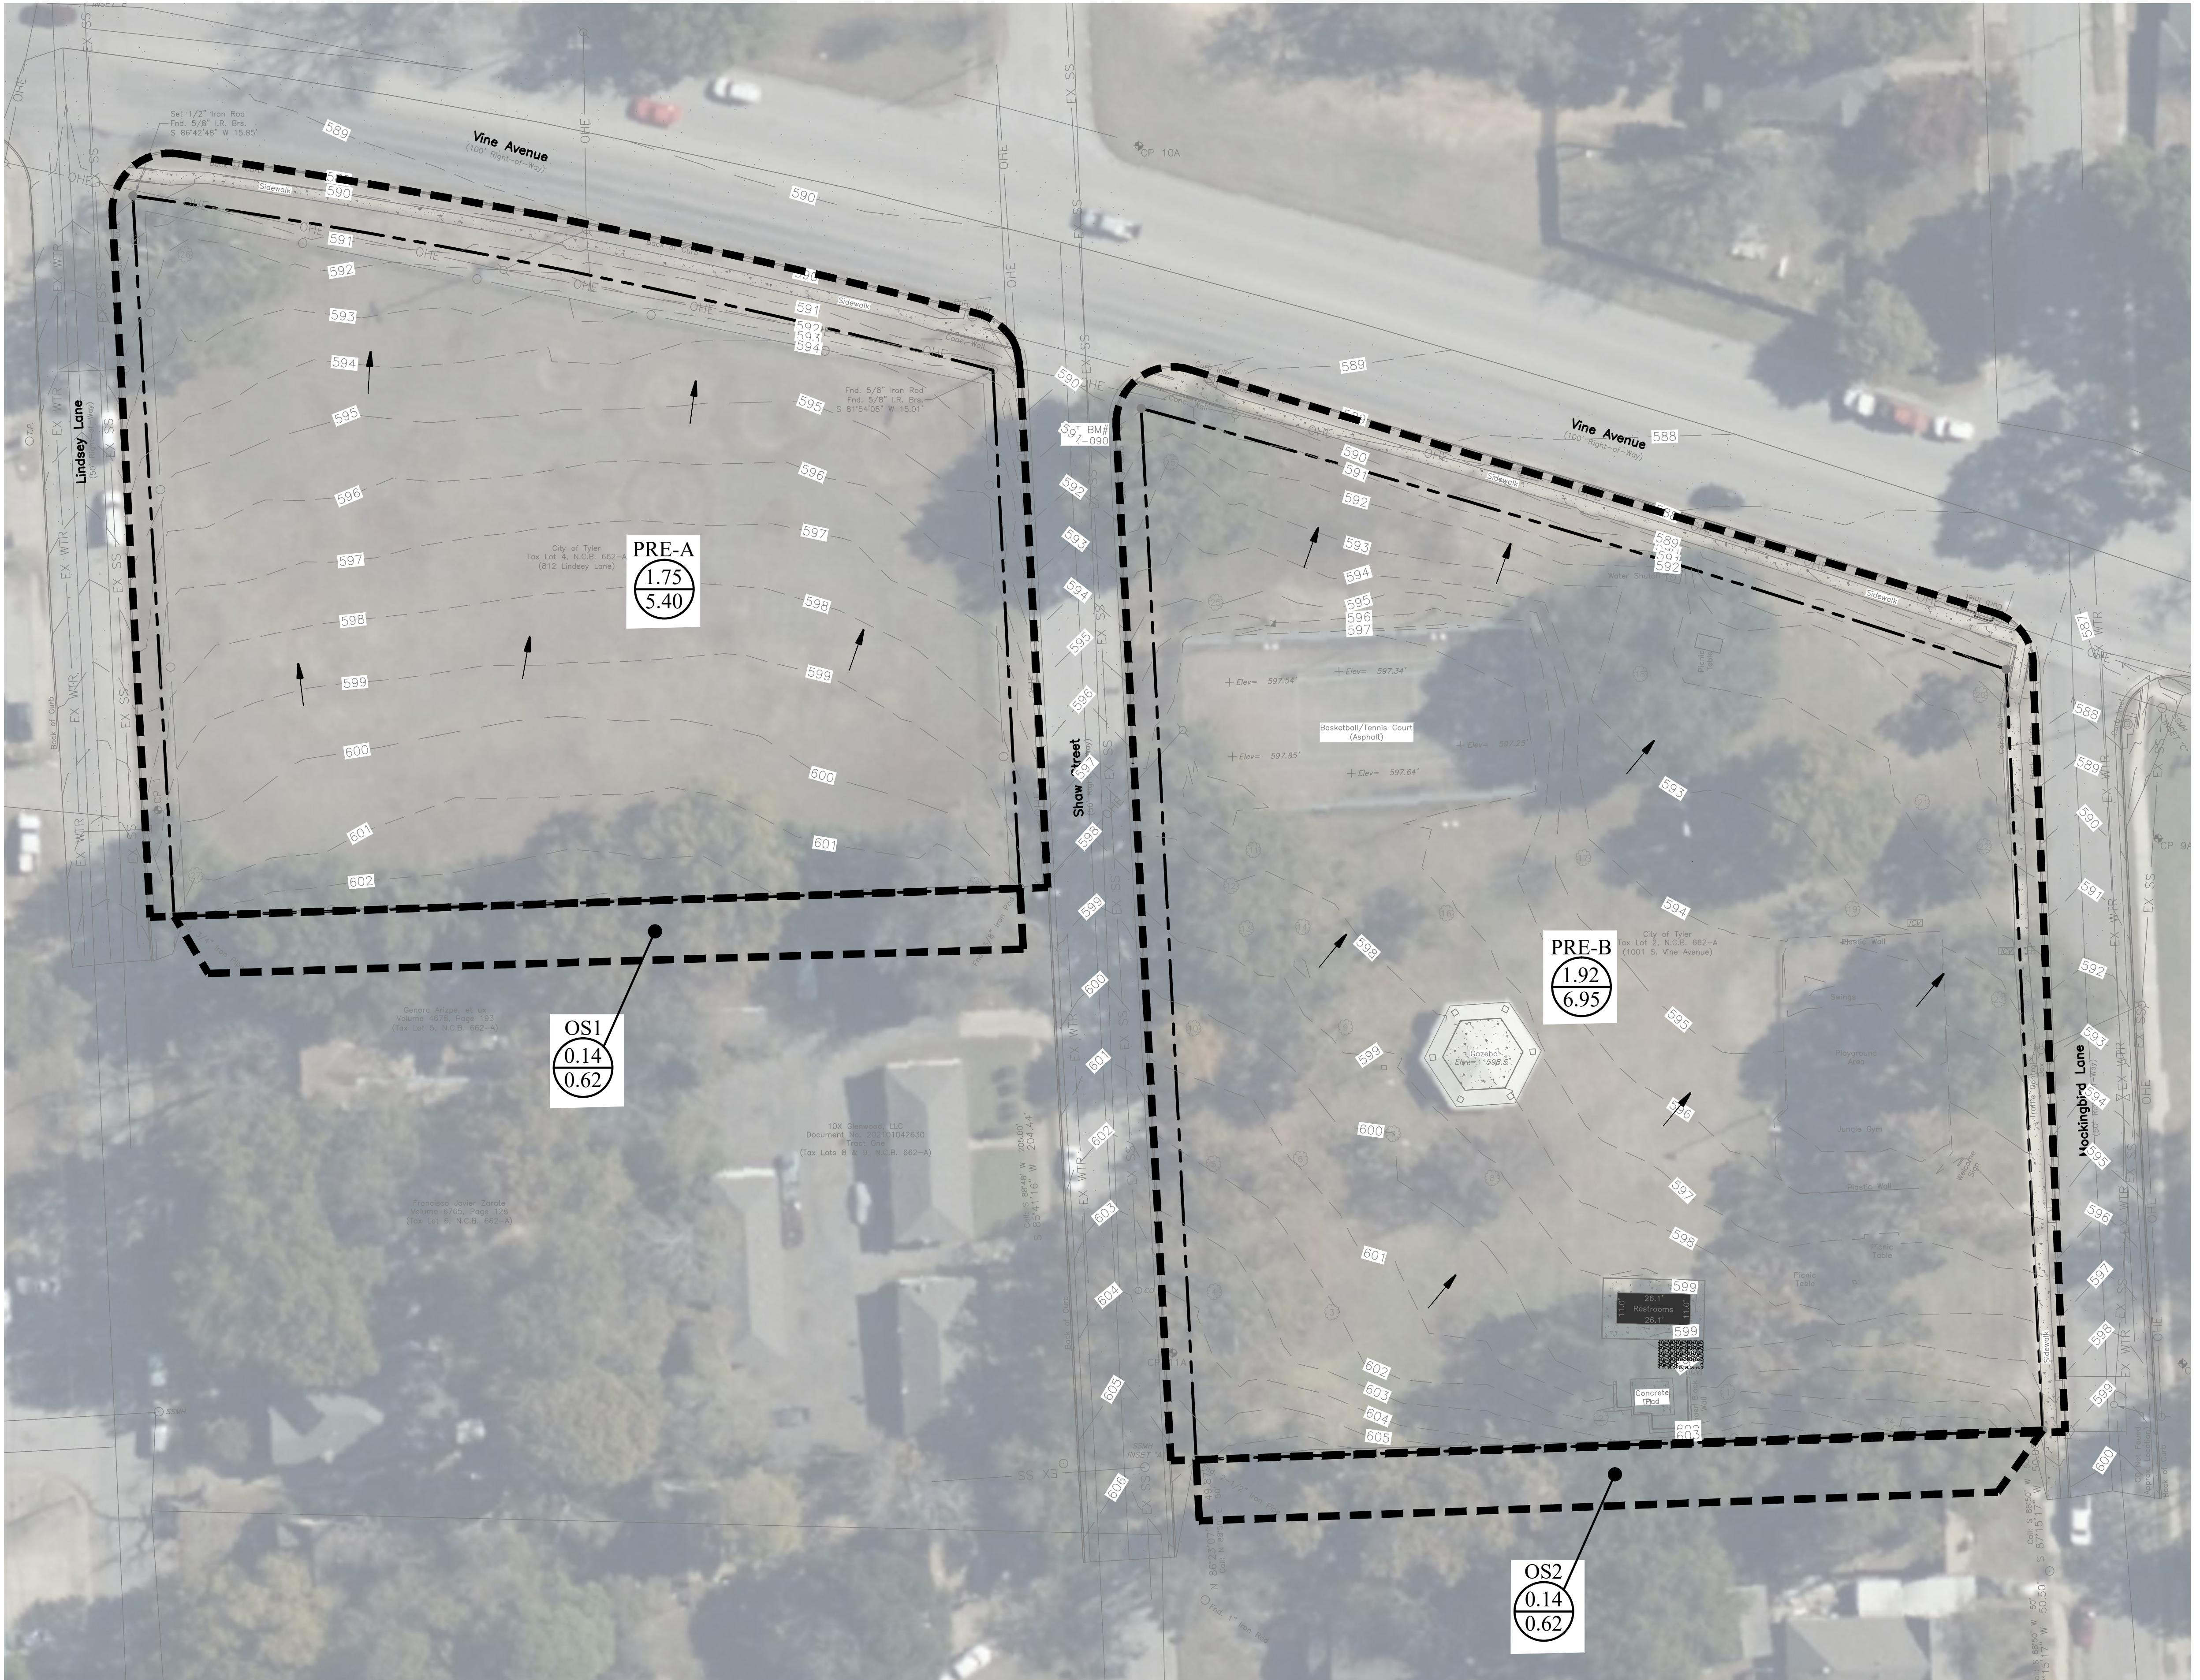

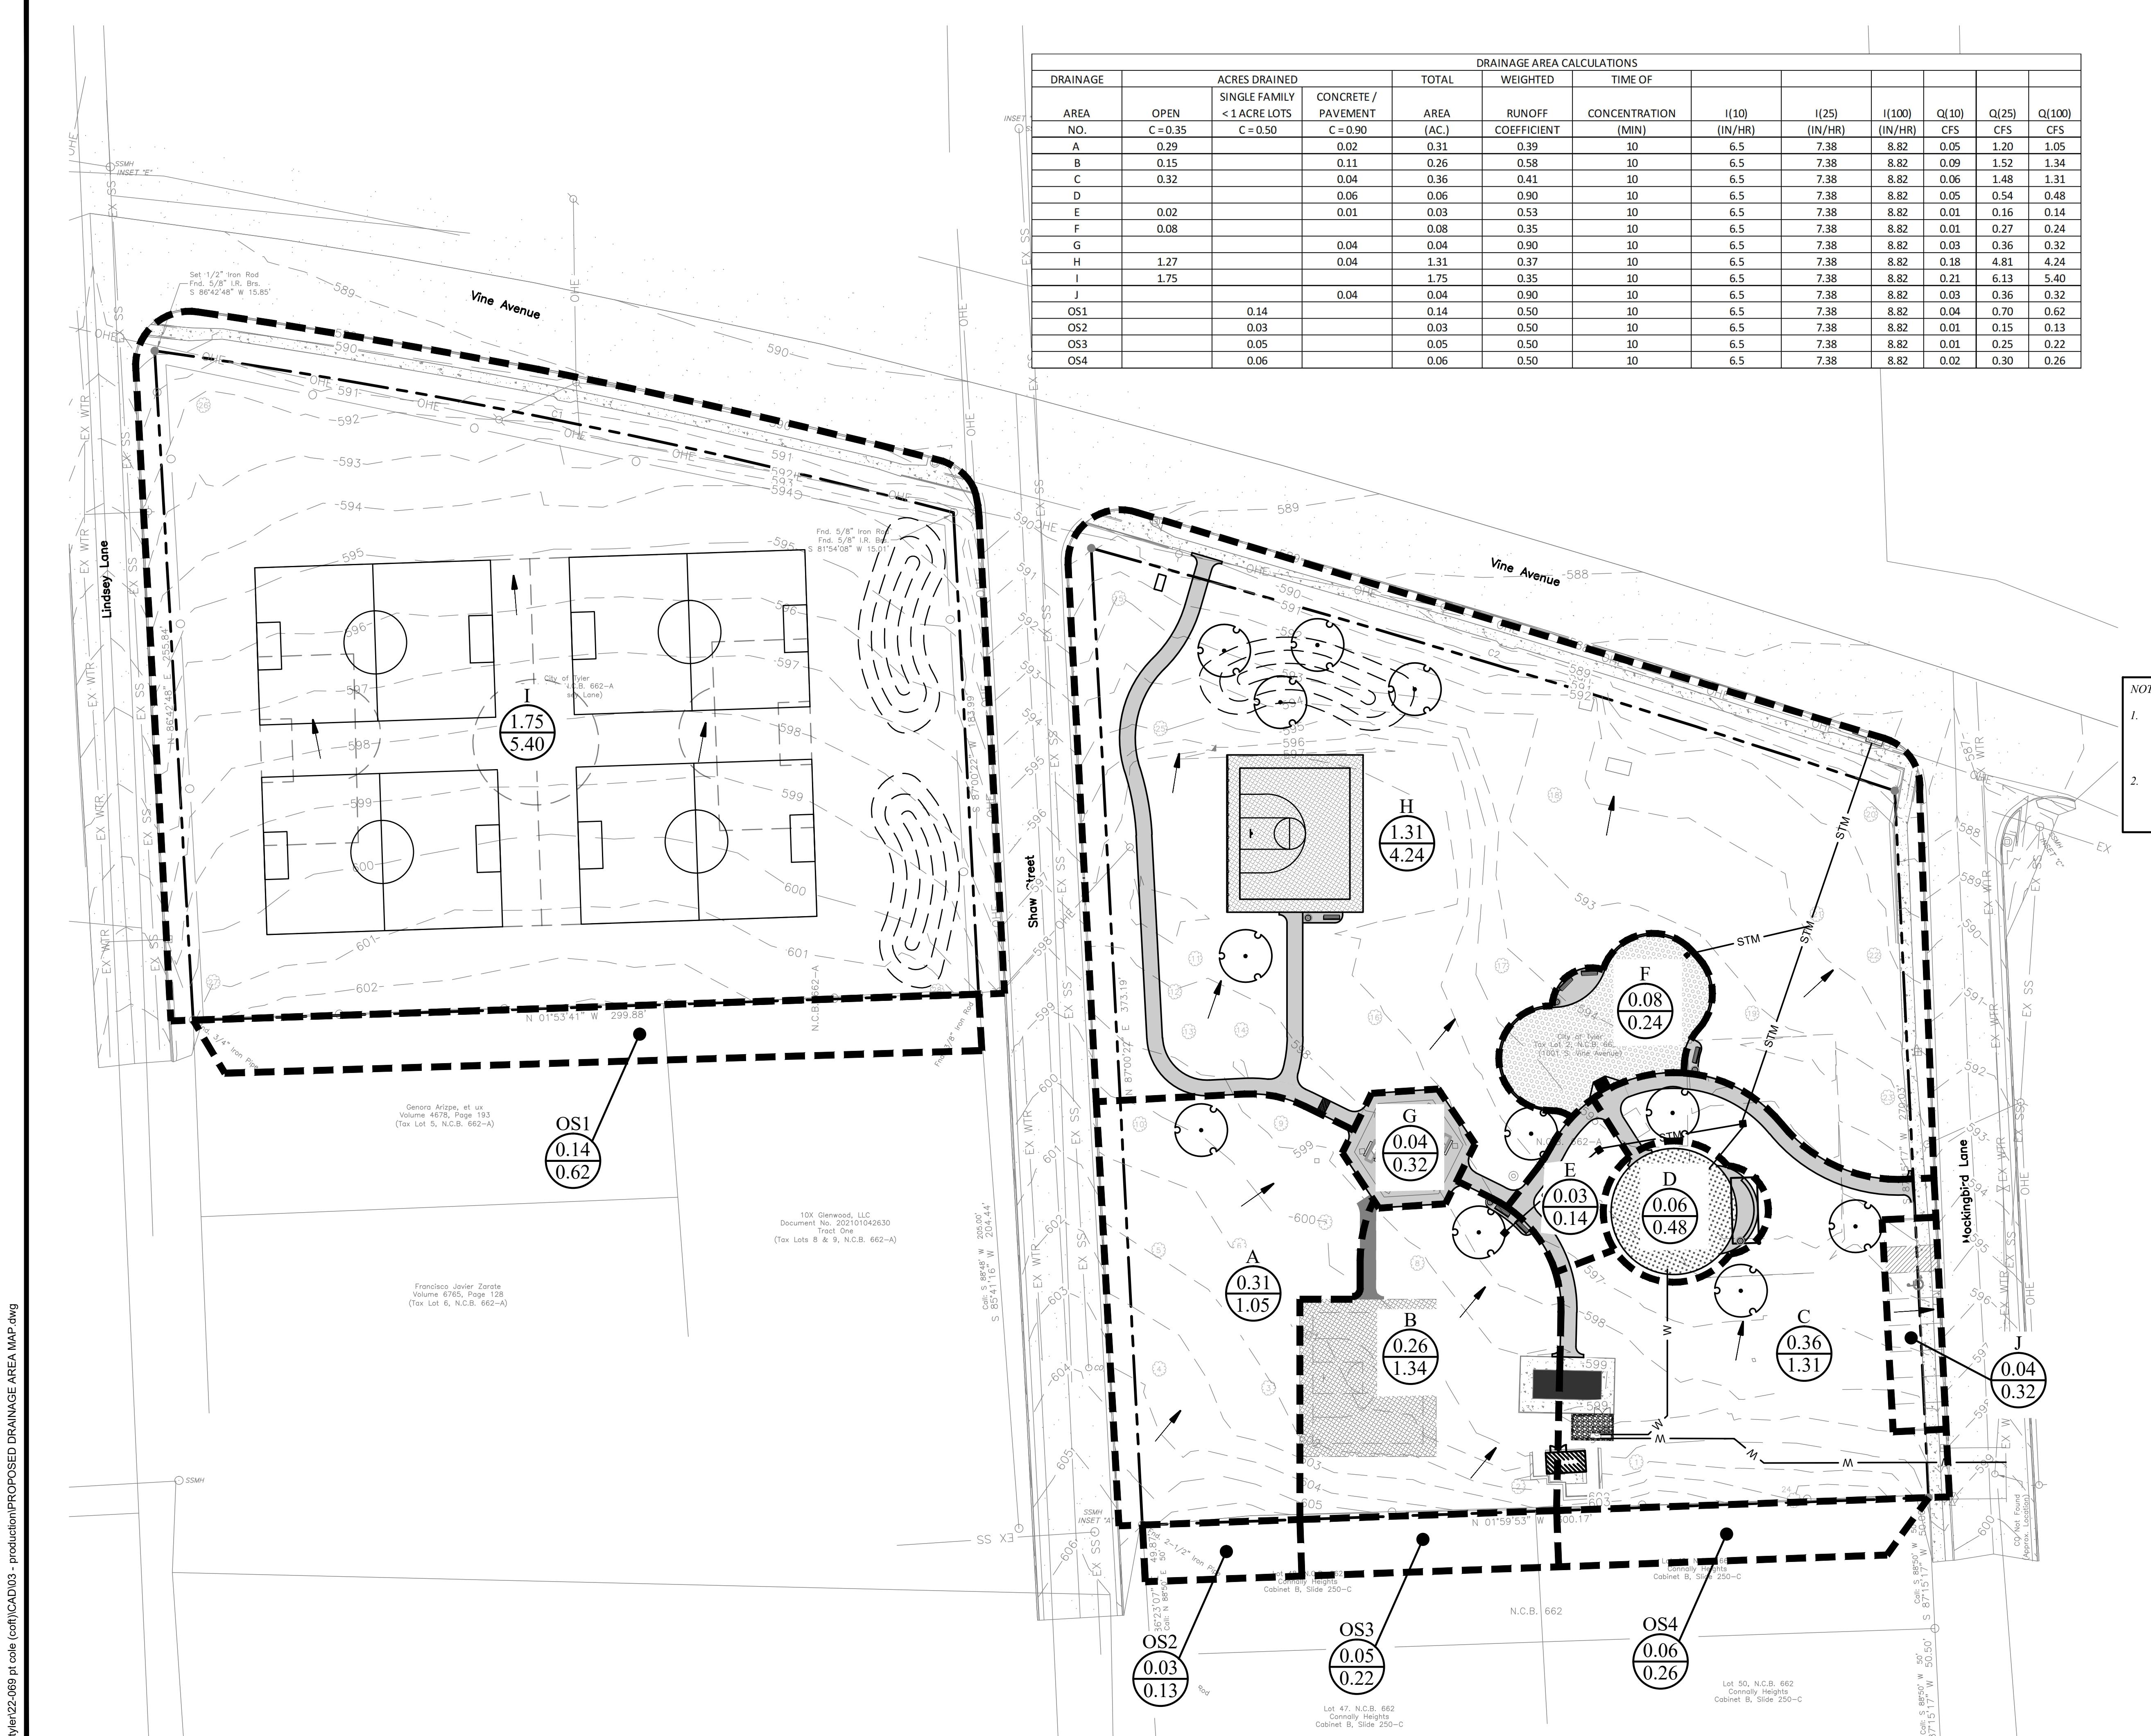

Know what's below.  
Call before you dig.



DRAWN: JHD  
CHECKED: WHS  
DATE: 10/11/2022  
SCALE: AS SHOWN  
JOB NO.: 22-069  
C9

## PROPOSED DRAINAGE AREA MAP

### P.T. COLE PARK

CITY OF TYLER, TEXAS

**MHS**  
PLANNING & DESIGN, LLC  
212 West Ninth Street, Tyler, Texas 75701  
903.597.6606

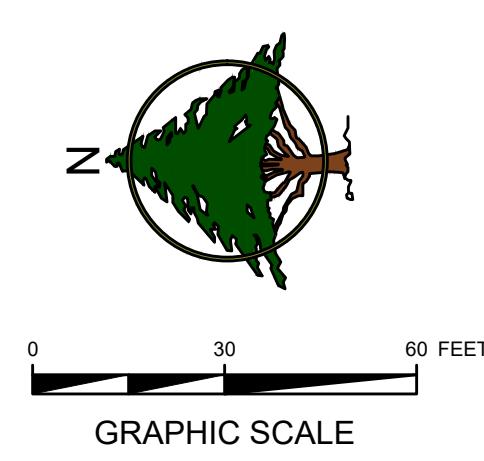
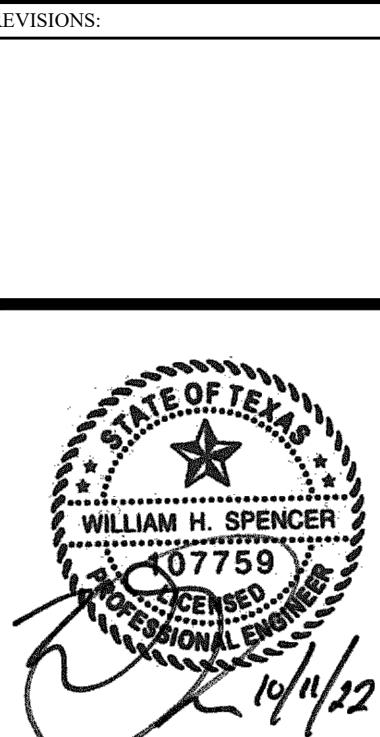


**LEGEND**

- EXISTING CONTOUR
- PROPOSED CONTOUR
- DRAINAGE AREA


**NOTES:**

1. OFFSITE AREAS ARE MINIMAL DUE TO ADJACENT PROPERTY ROOF LINES AND DRIVEWAYS DRAINING TO THE NORTH AND SOUTH OUT TO THE ROADWAYS.
2. ON SITE PROPOSED DRAINAGE AREAS INCLUDE FUTURE ELEMENTS TO DETERMINE DRAINAGE CAPACITY OF INLETS AND PIPES WITH ALL AMENITIES.

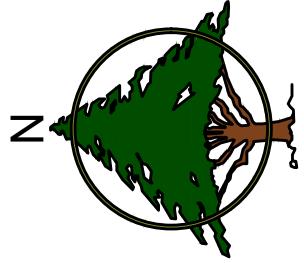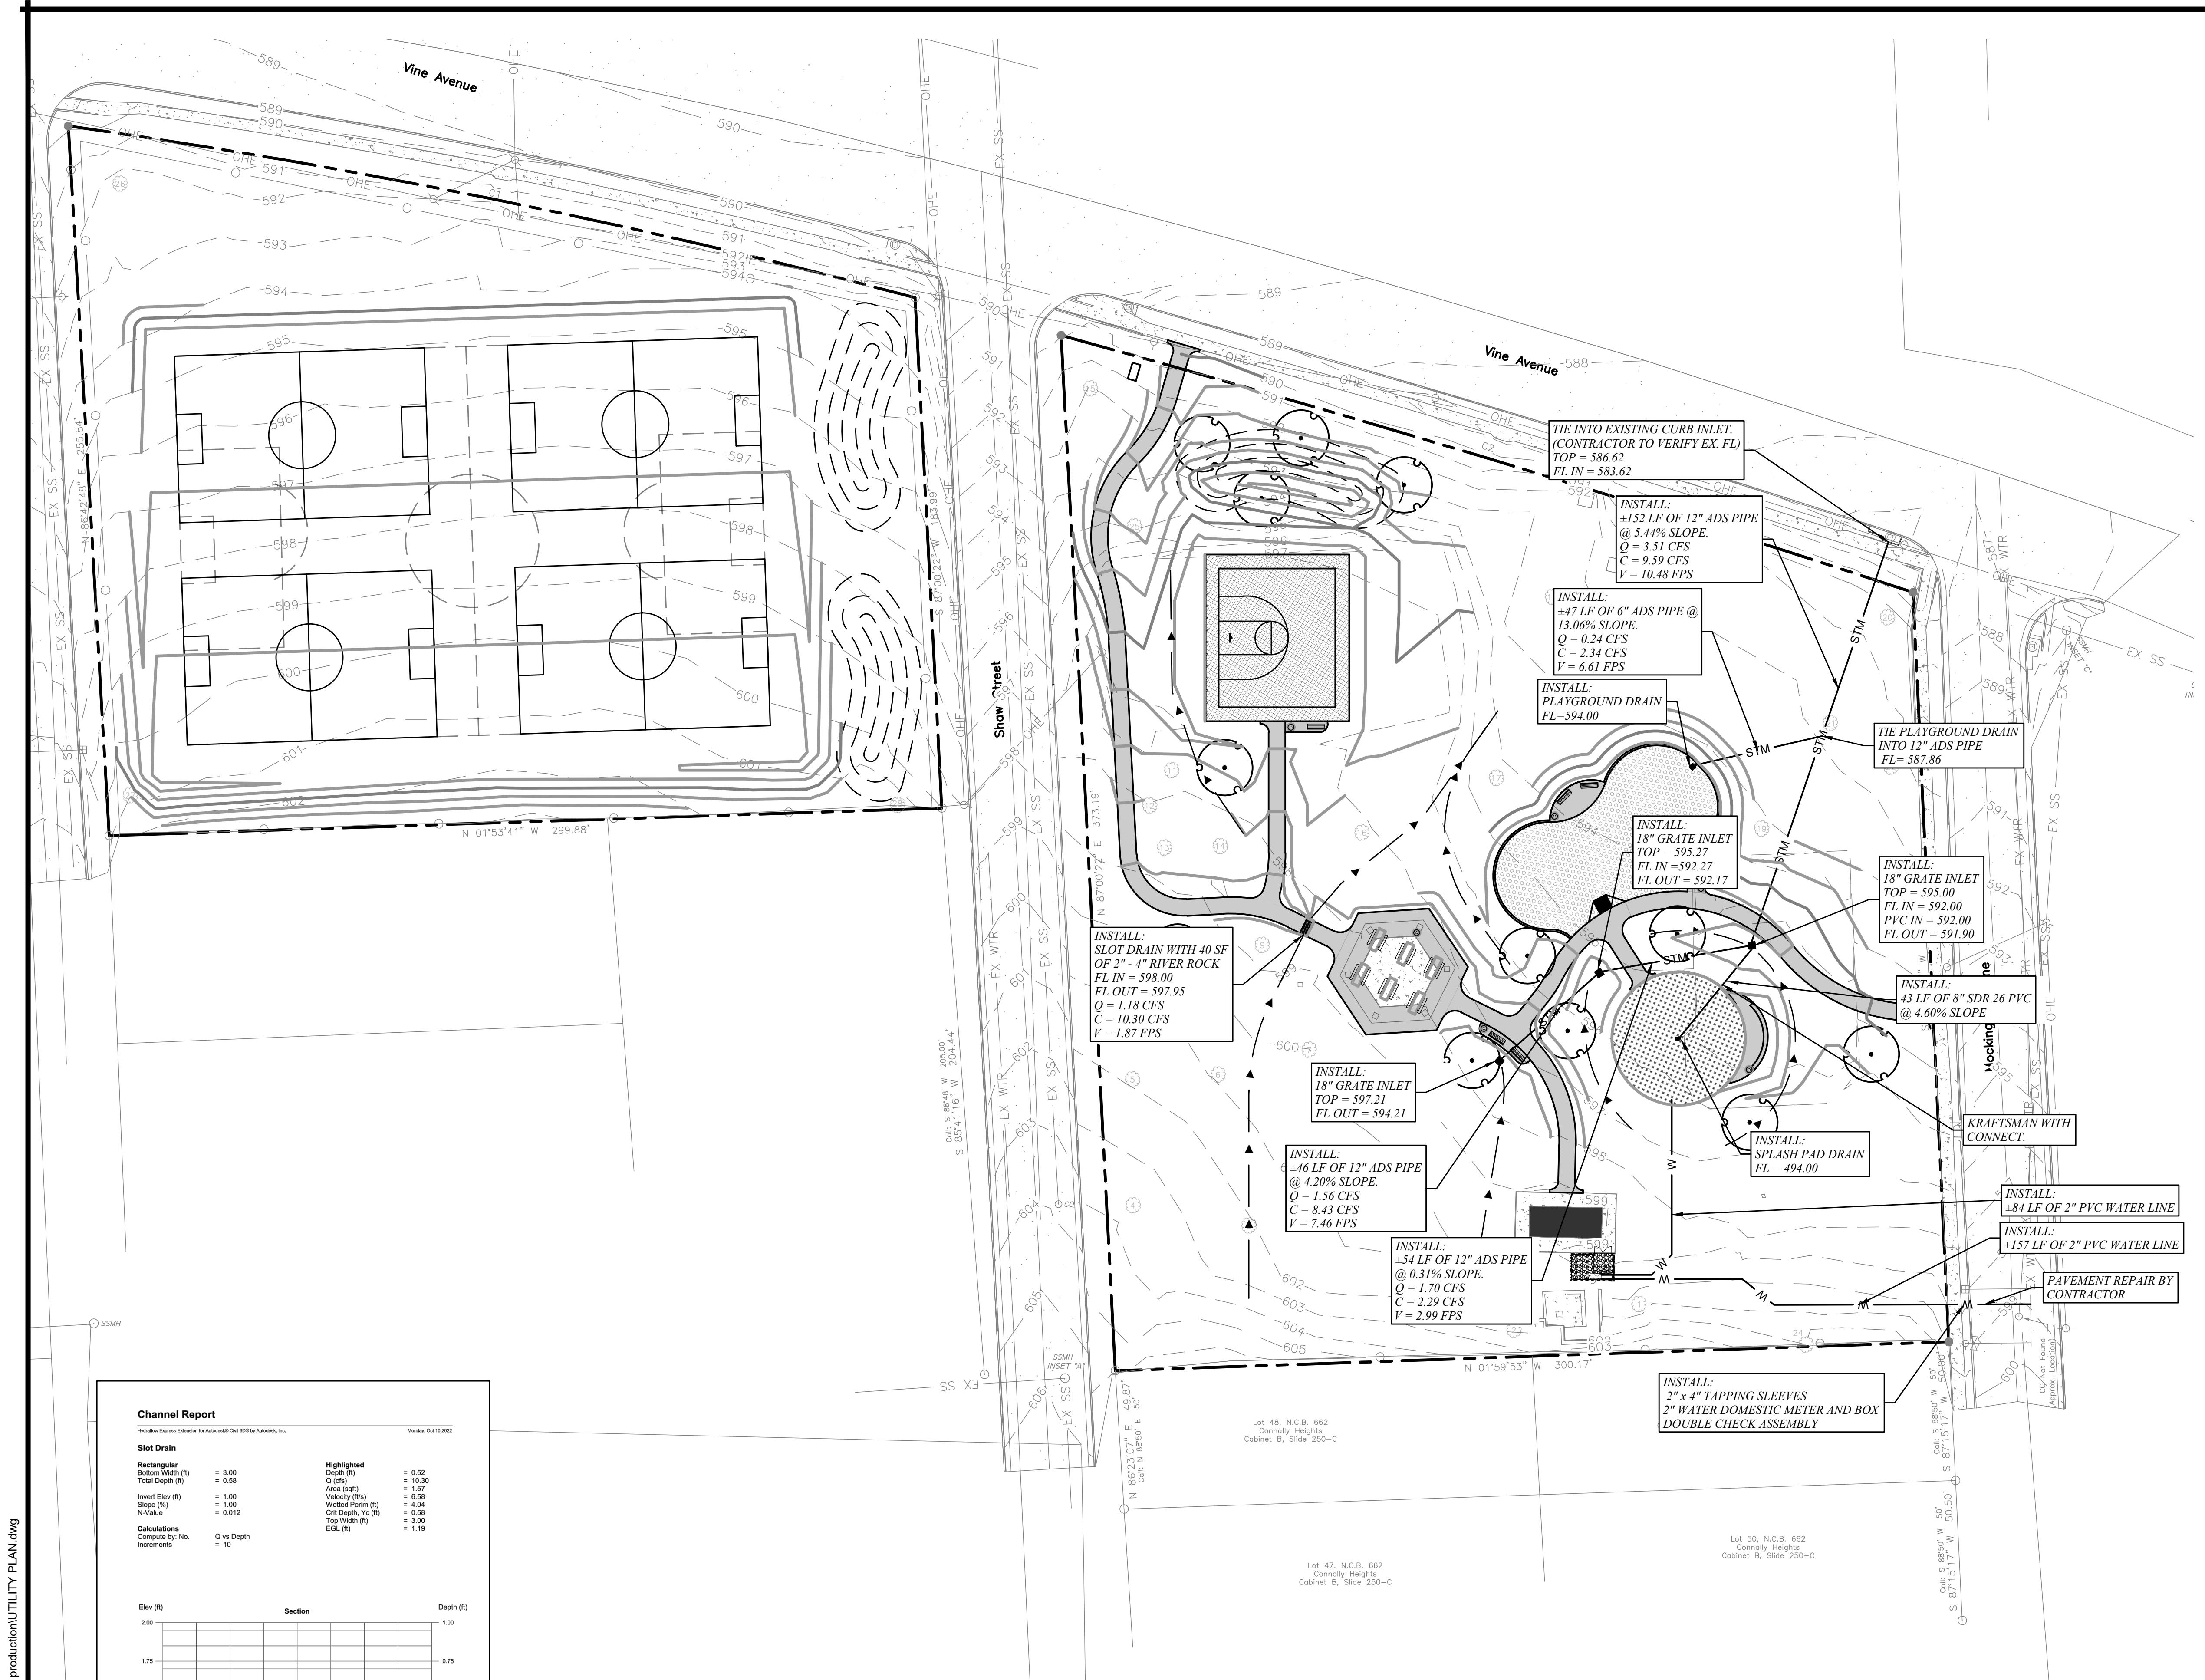

30 60 FEET

GRAPHIC SCALE

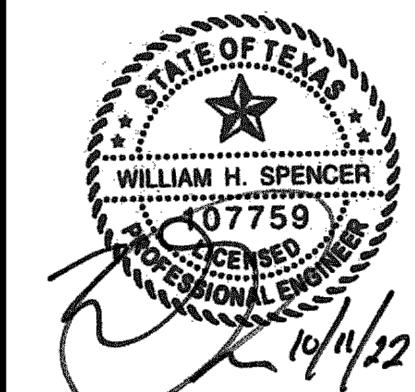

The logo for VIEHS Planning & Design, LLC. It features a large, bold, serif font where the letters 'V', 'I', 'E', 'H', and 'S' are stacked vertically. Behind the letters is a circular emblem containing a stylized green tree with a thin trunk and branches. The background of the entire logo is a light green color.

# P.T. COLE PARK CITY OF TYLER, TEXAS

# DRAINAGE & UTILITY PLAN

# TREE TABLE

Point	Size	Type
1	24"	Live Oak
2	36"	Post Oak
3	8"	Red Bud
4	54"	Water Oak
5	10"	Chinese Pistache
6	18"	Sycamore
7	20"	Sycamore
8	18"	Chinquapin Oak
9	26"	Sycamore
10	15"	Pin Oak
11	24"	Water Oak
12	15"	Water Oak
13	15"	Water Oak
14	18"	Pin Oak
15	48"	Pin Oak
16	14"	Burch
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18	50"	Live Oak
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22	14"	Pecan
23	38"	Pin Oak
24	36"	Water Oak
25	10"	Chinese Pistache
26	42"	Water Oak
27	15"	Water Oak
28	42"	Hackberry


*NOTE: CONTRACTOR TO CONFIRM THAT  
ON SITE PSI MEETS REQUIRED PSI FOR  
KRAFTSMAN SPRAYGROUND SYSTEM.*




Know what's below.  
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AWN: **MEP**  
ECKED: **WHS**  
TE: **10/11/2022**  
ALE: **AS SHOWN**  
B NO.: **22-069**

C10



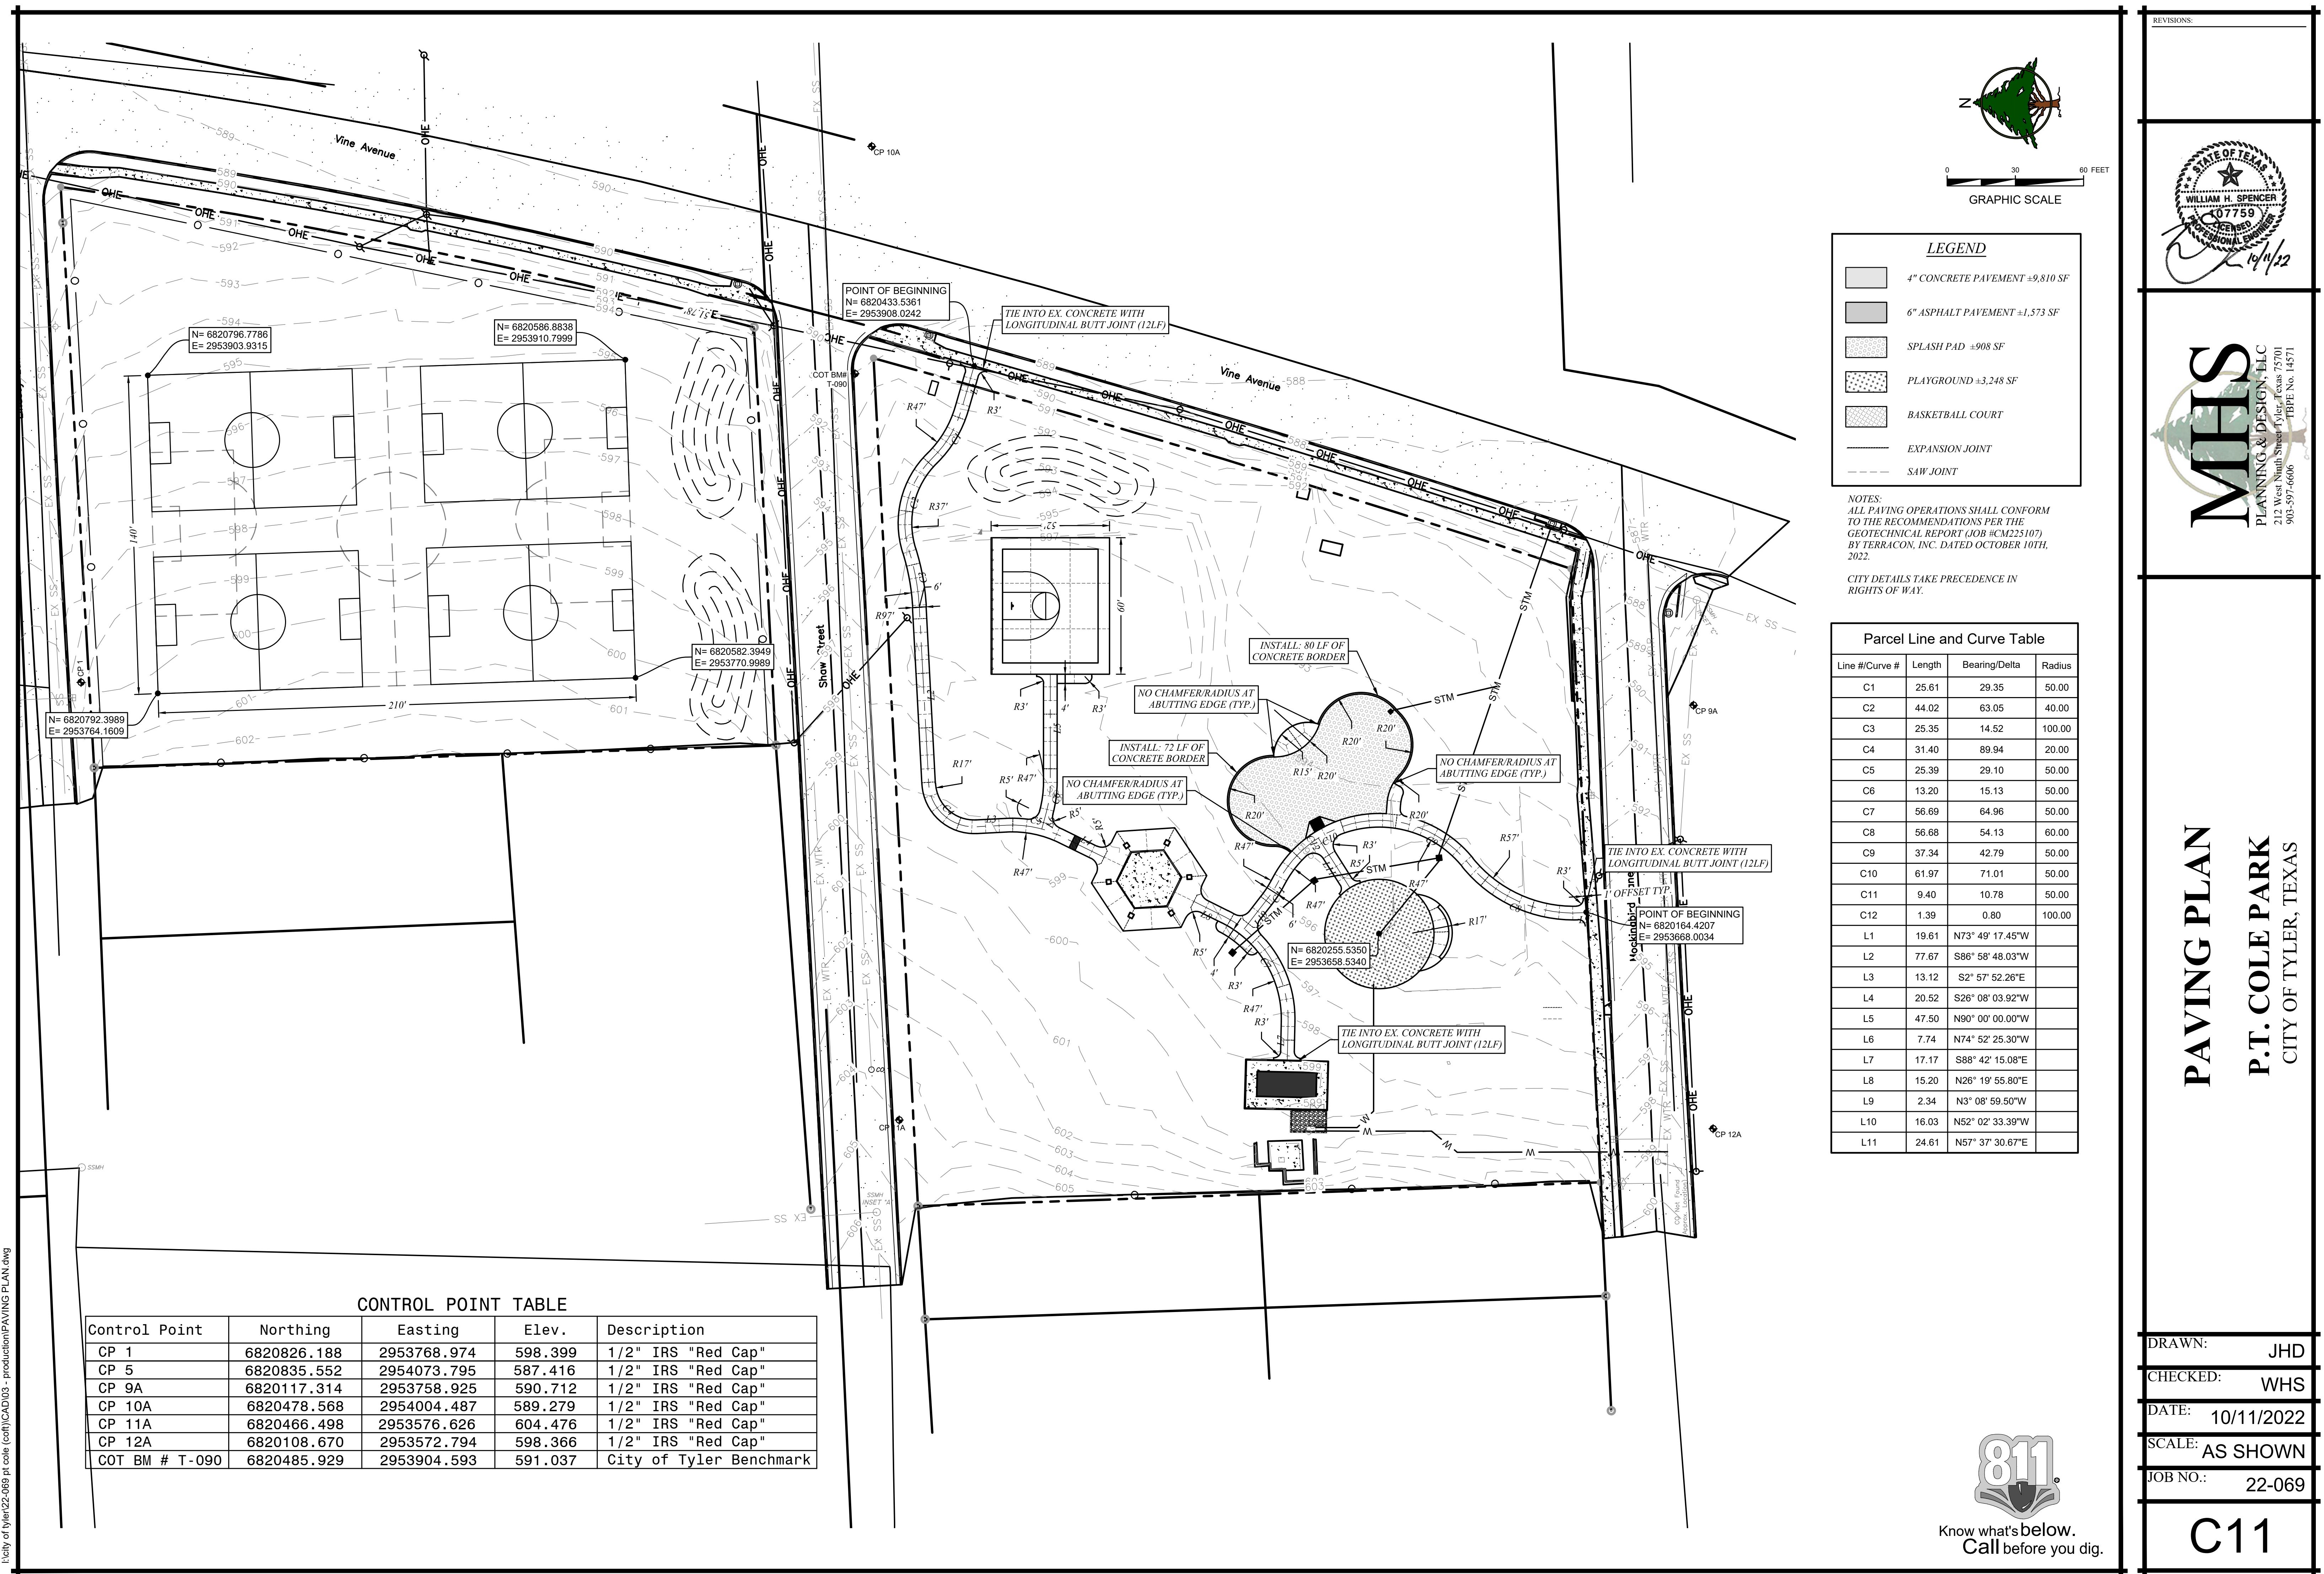



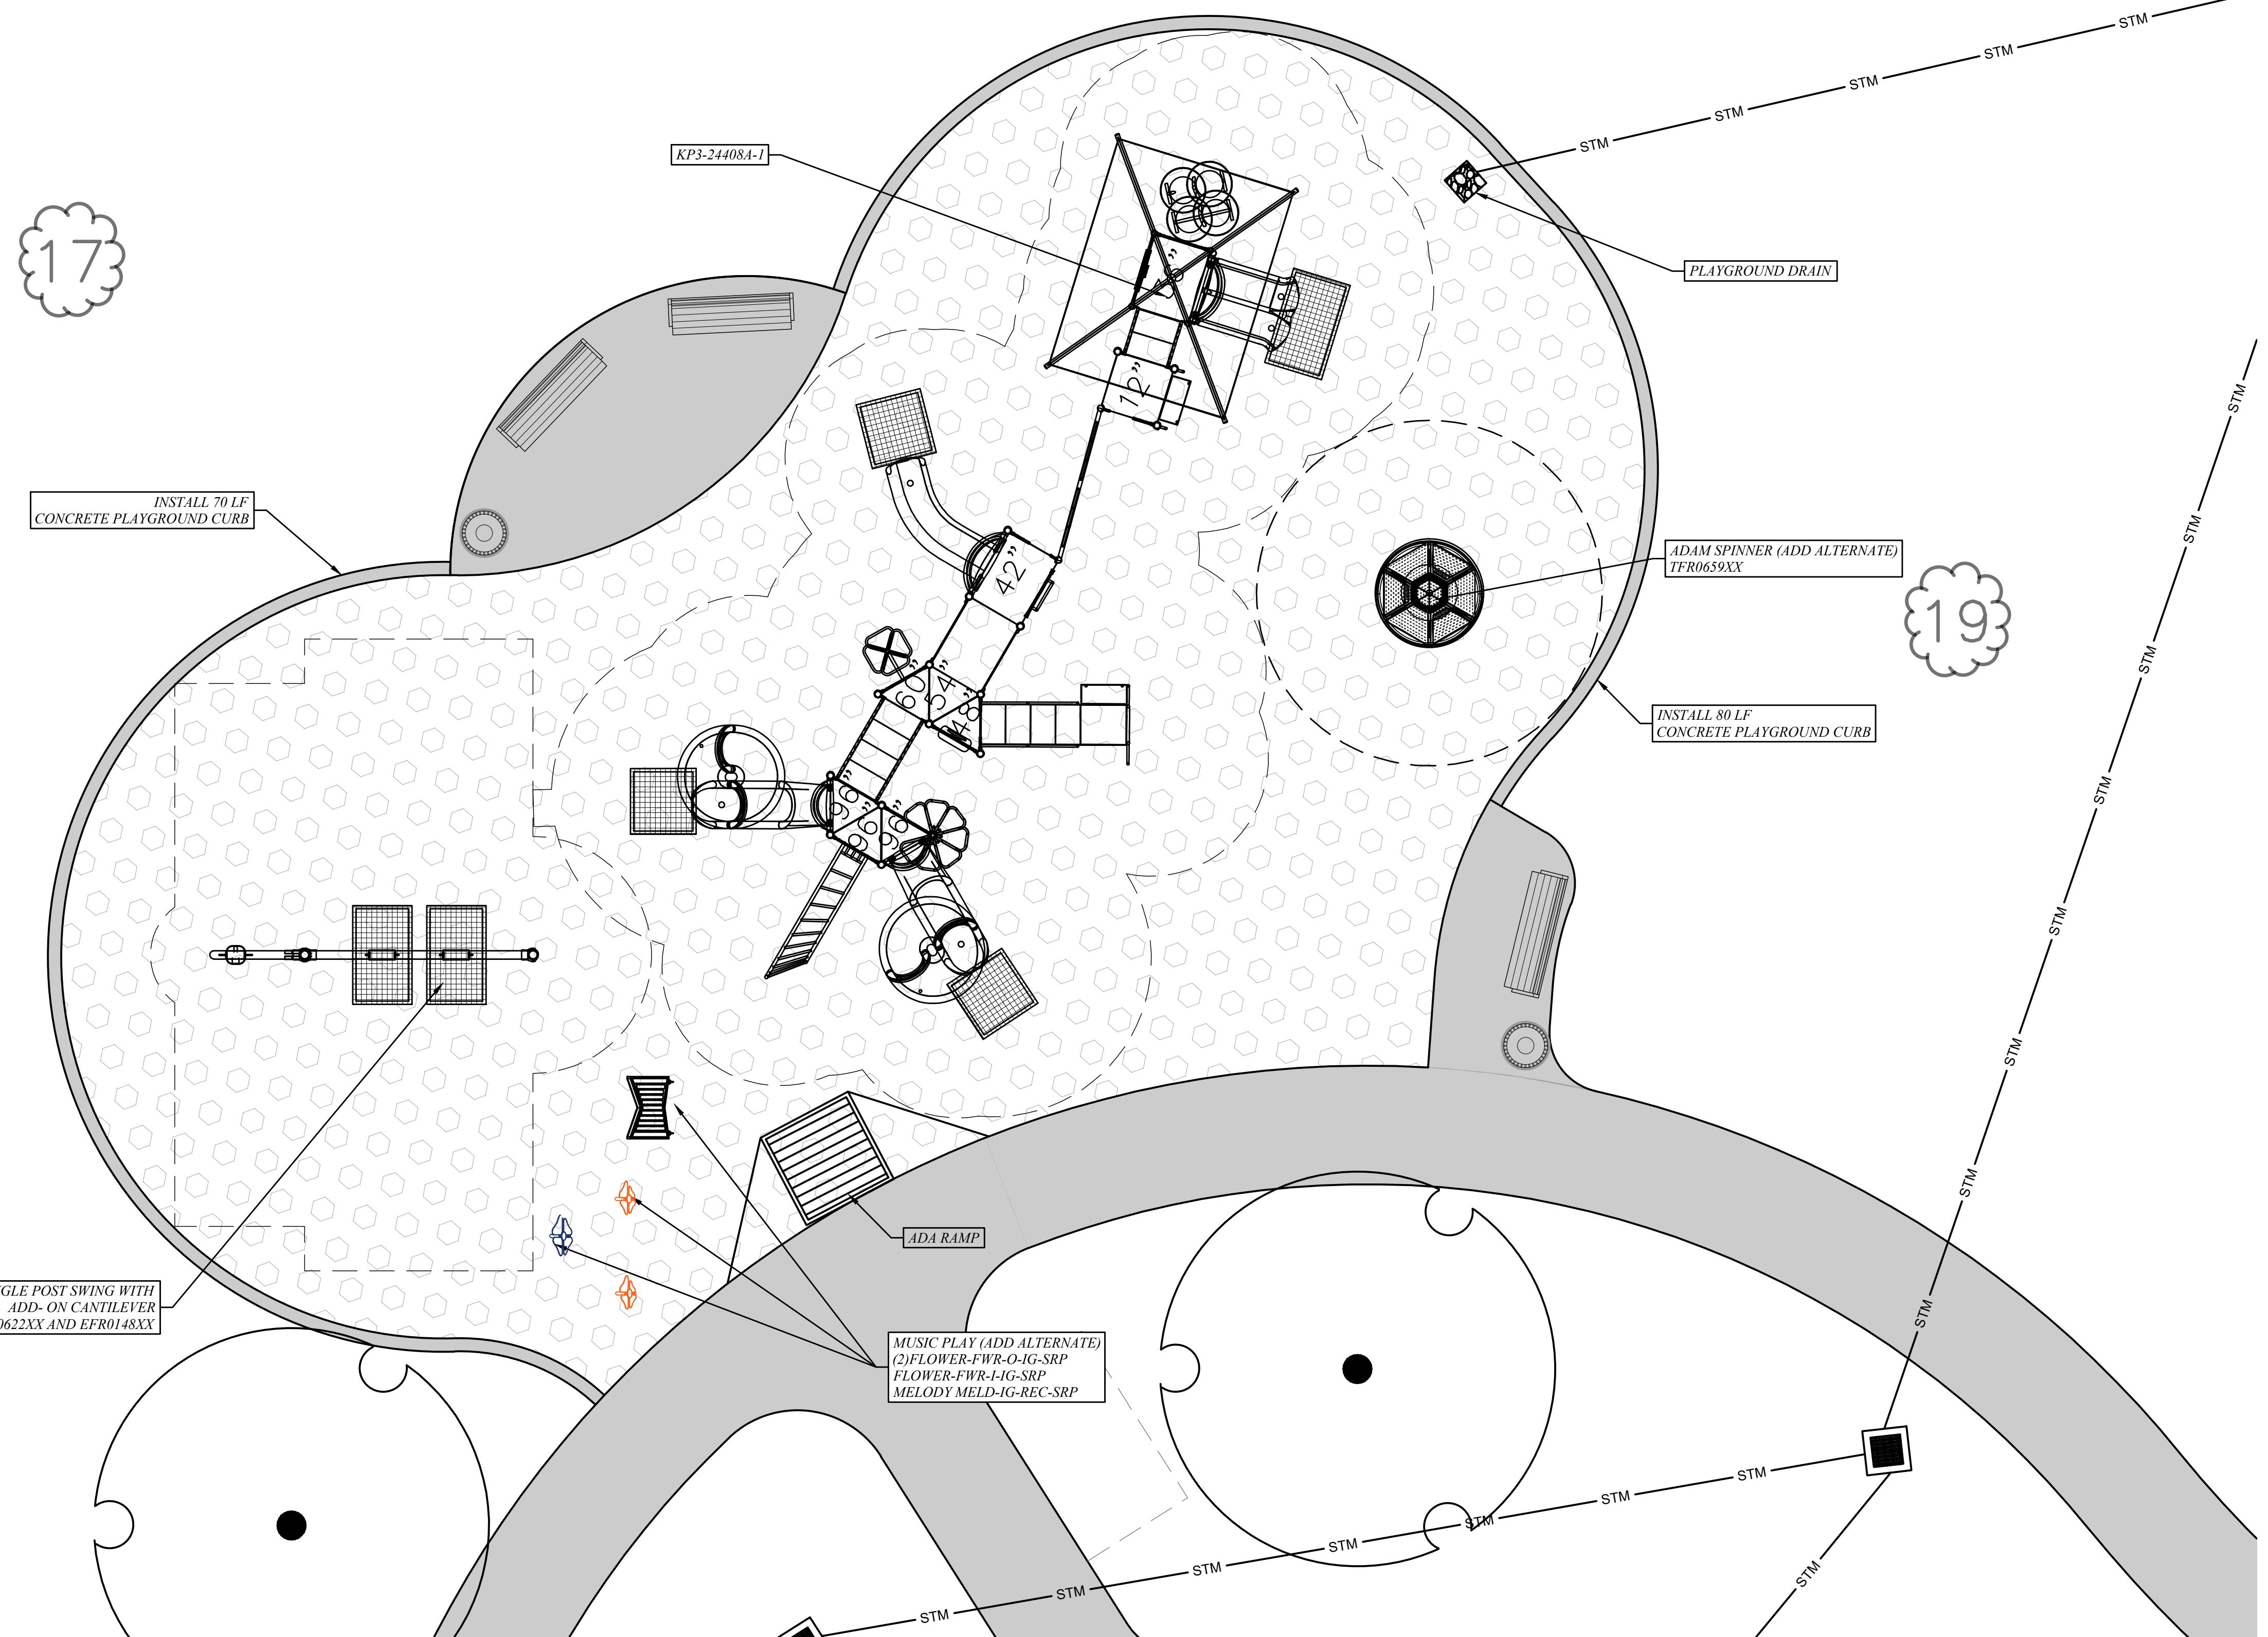
Know what's below.  
Call before you dig.

C12

## PLAYGROUND PLAN

P.T. COLE PARK  
CITY OF TYLER, TEXAS

REVISIONS:

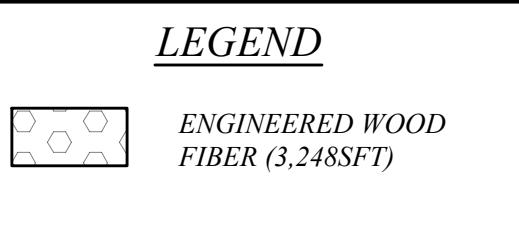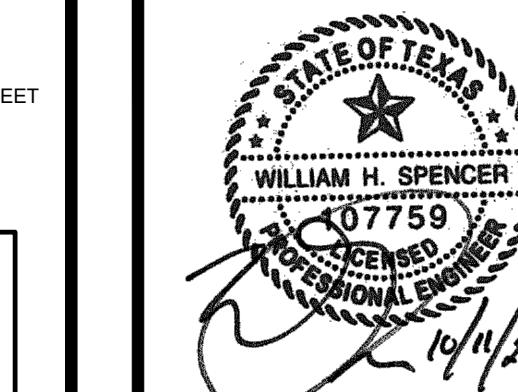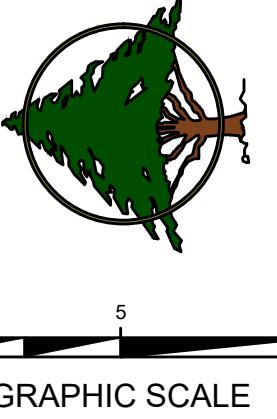


NOTES:

1. ALL PLAY EQUIPMENT MAY BE SUBSTITUTED FOR AN APPROVED EQUAL.
2. EQUIPMENT COLORS TO BE SELECTED BY OWNER FROM STANDARDS.
3. PLAYGROUND SUPPLIER TO PROVIDE STAMPED ENGINEERING PLANS FOR THE CITY OF TYLER APPROVAL UPON ORDER.
4. PLAYGROUND IS TO BE A BUYBOARD PURCHASE.

CONTACT:  
RYAN SLOTT  
KRAFTSMAN SALES-EAST TEXAS  
214-282-9580  
RYANS@KRAFTSMANPLAY.COM

DRAWN:	MEP
CHECKED:	WHS
DATE:	10/11/2022
SCALE:	AS SHOWN
JOB NO.:	22-069

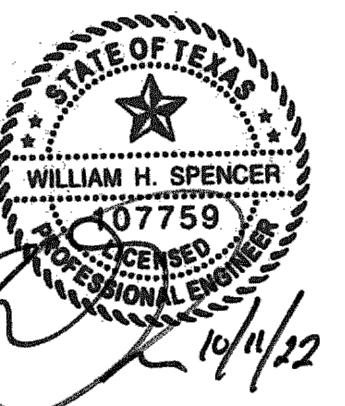

**WHS**  
PLANNING & DESIGN, LLC  
212 West Ninth Street, Tyler, Texas 75701  
903.597.6606

## P.T. COLE PARK

CITY OF TYLER, TEXAS

## SPRAYGROUND PLAN


- NOTES:
1. ALL EQUIPMENT MAY BE SUBSTITUTED FOR AN APPROVED EQUAL.
  2. KRAFTKOA DESIGN AND COLORS TO BE SELECTED BY OWNER FROM STANDARDS.
  3. SPRAYGROUND SUPPLIER TO PROVIDE STAMPED ENGINEERING PLANS FOR THE CITY OF TYLER APPROVAL UPON ORDER.
  4. ANY SHADE STRUCTURES TO BE ADD ALTERNATE.
  5. SPRAYGROUND IS TO BE BUYBOARD PURCHASE.

CONTACT:  
RYAN SLOTT  
KRAFTSMAN SALES-EAST TEXAS  
214-282-9380  
RYANS@KRAFTSMANPLAY.COM



Know what's below.  
Call before you dig.

C13

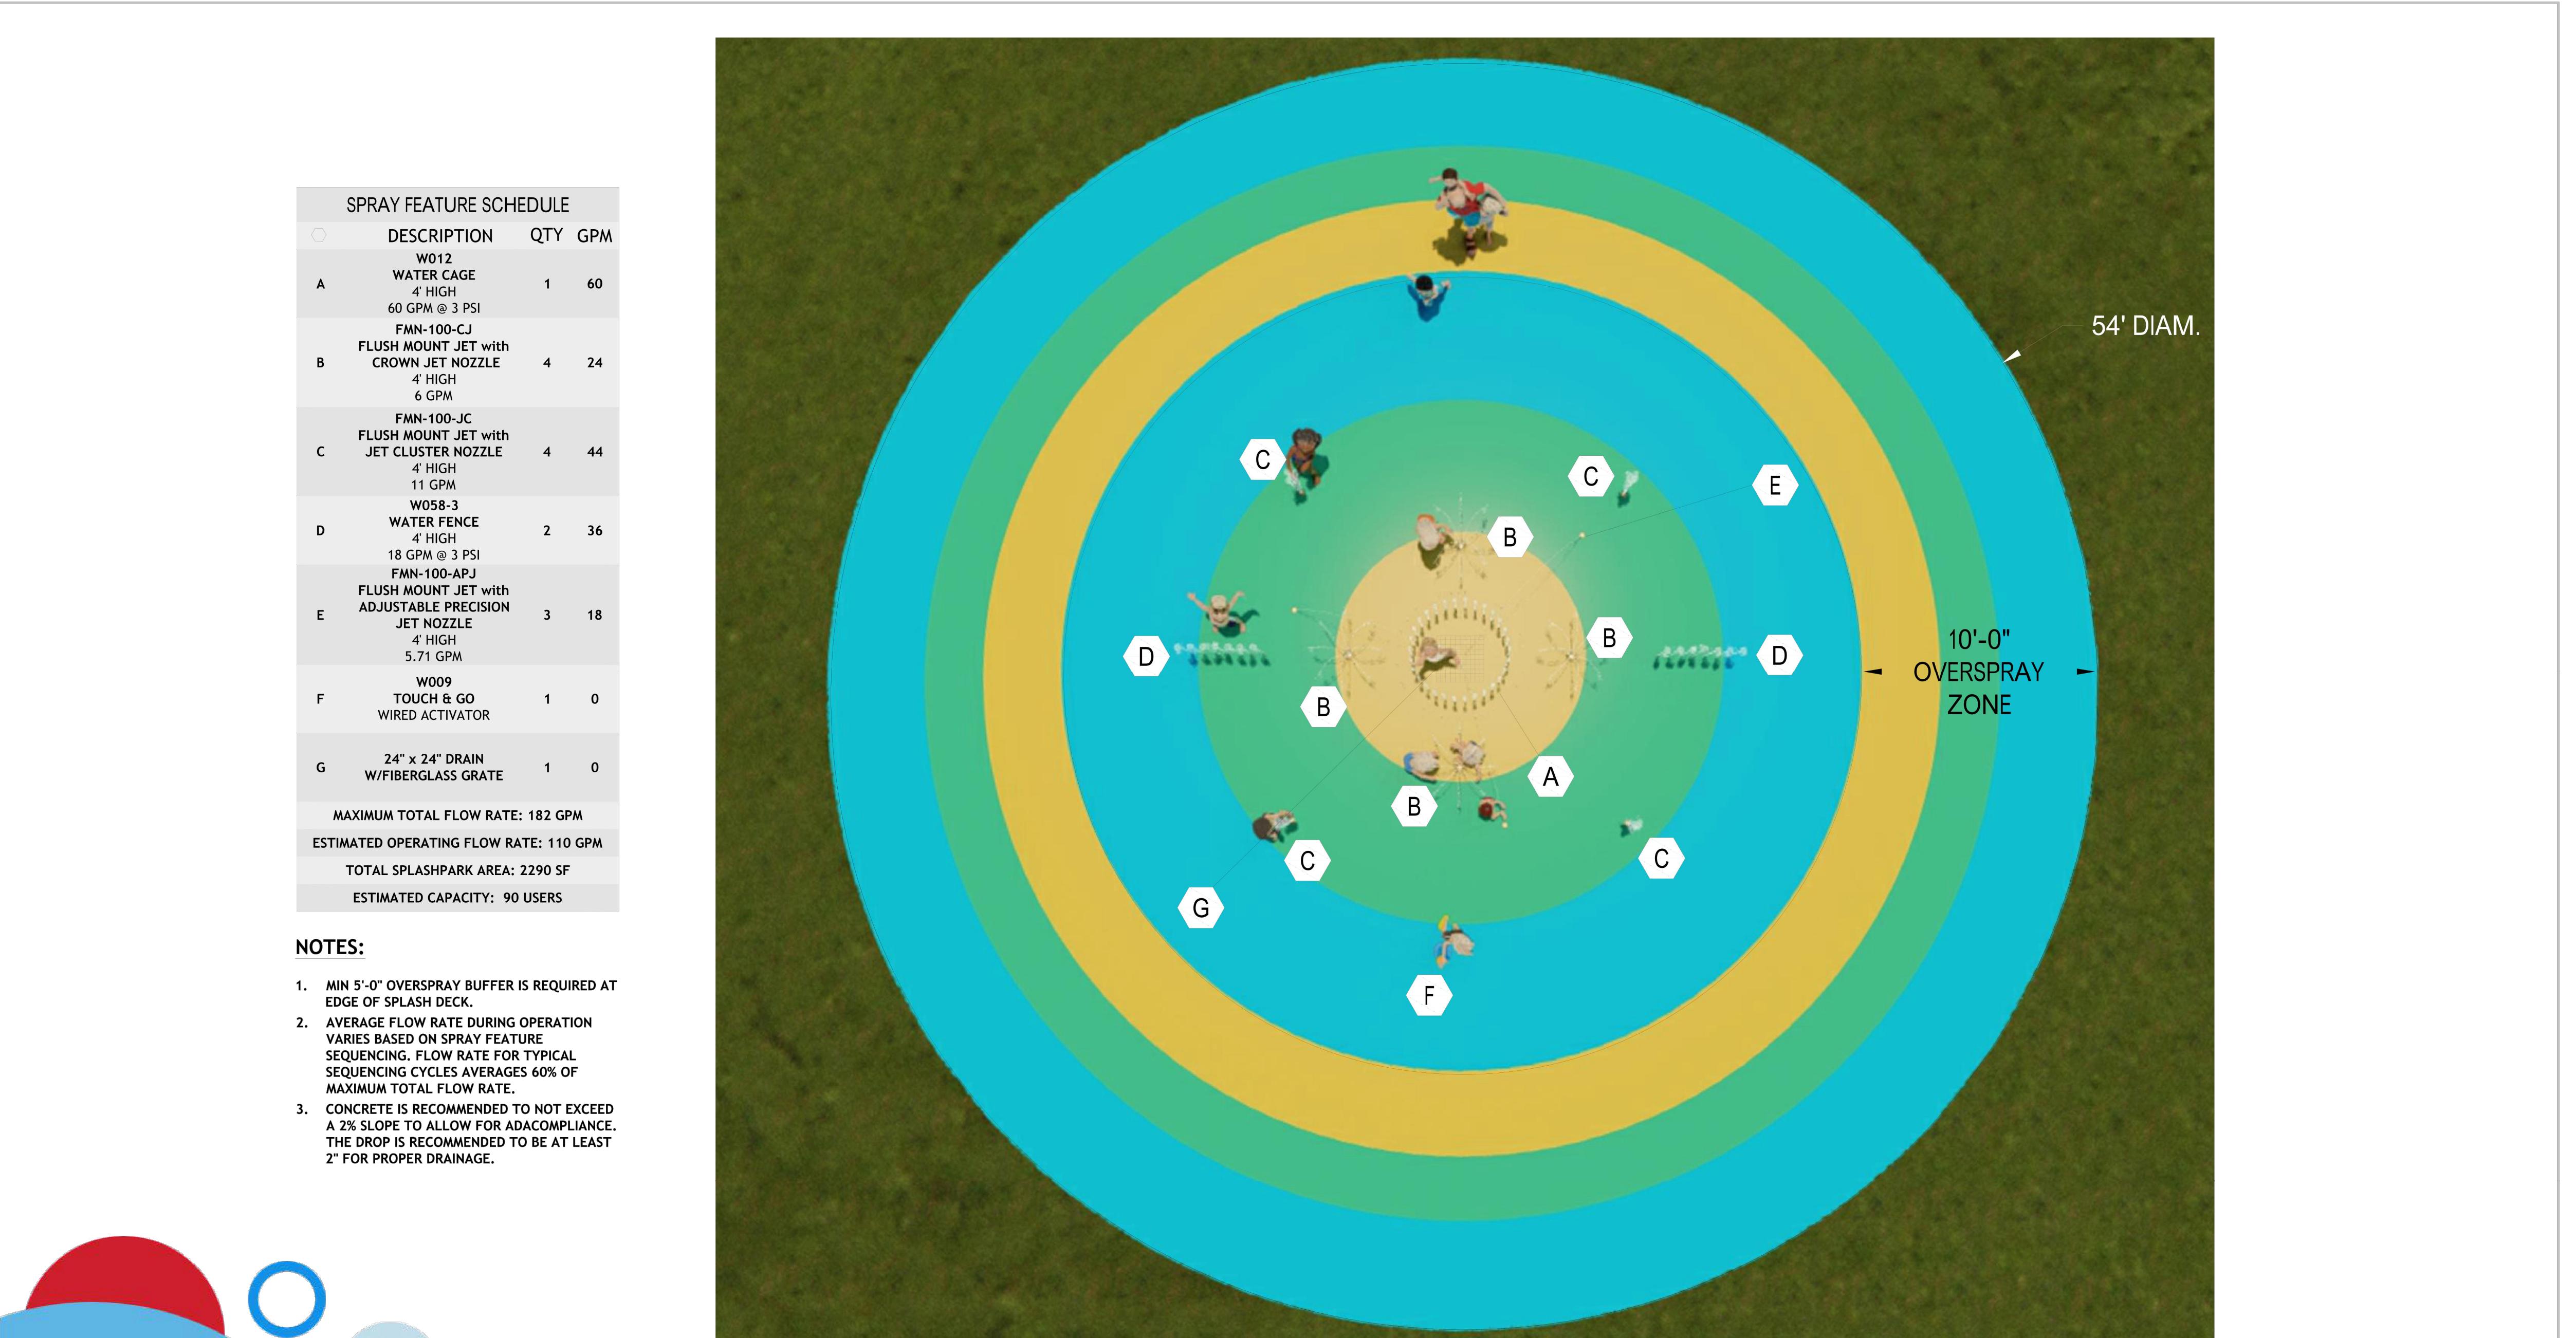

P.T. Cole Park SplashPark  
Tyler, TX

Project 28312  
Option 3

Drawing Name  
KPS-28312-3

Sheet  
K.3

View  
SplashPark Feature Layout


Designer  
MZB

Sales Rep.  
Ryan Slott

Date  
10.05.2022

DRAWN: MEP  
CHECKED: WHS  
DATE: 10/11/2022  
SCALE: AS SHOWN  
JOB NO.: 22-069



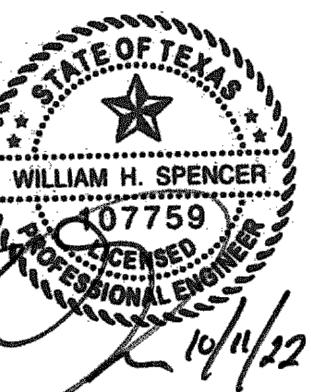

**WHS**  
PLANNING & DESIGN, LLC  
212 West Ninth Street, Tyler, Texas 75701  
903.597.6606

## P.T. COLE PARK CITY OF TYLER, TEXAS

# CONSTRUCTION DETAILS II

<p><b>SECTION VIEW</b> <b>EXPANSION JOINT DETAIL</b> N.T.S.</p> <p>NOTES: 1. NO. 5 SMOOTH DOWEL BAR MAY BE USED IN 5 INCH AND 6 INCH PAVEMENT THICKNESS. 2. LONGITUDINAL BUTT JOINT CONSTRUCTION MAY BE UTILIZED IN PLACE OF LONGITUDINAL HINGE (KEYWAY) JOINT AT CONTRACTOR'S OPTION. 3. DOWEL BARS SHALL BE 18" O.C. AND PLACED HORIZONTALLY BY USE OF MECHANICAL RIG AND COATED IN EPOXY RESIN. DRILL HOLES SHALL BE 3/4" AND BLOWN CLEAN. 4. DRILLED BY HAND IS NOT ACCEPTABLE. PUSHING DOWEL BARS INTO GREEN CONCRETE IS NOT ACCEPTABLE.</p>	<p><b>SAWCUT FULL DEPTH &amp; CURB &amp; GUTTER 9"-15"</b> T= PAVEMENT THICKNESS 24" DEFORMED NO.4 DOWEL BAR TOP 1/4" NO SEALING COMPOUND VERTICAL SAW CUT 3/8" MIN. HOT Poured RUBBER JOINT SEALING COMPOUND PROPOSED PAVEMENT EXISTING PAVEMENT DOWEL SPACED ON TWO (2) FOOT CENTER TO CENTER, 6 INCHES OFF TIE BARS. NOTE: DOWELS AND REINFORCING BARS SHALL BE SUPPORTED BY AN APPROVED DEVICE. <b>LONGITUDINAL BUTT JOINT</b> N.T.S.</p> <p><b>SAWED DUMMY (CONTROL) JOINT</b> N.T.S. MAXIMUM SPACING IS 15' CTRS. (TYP.)</p>	<p><b>SAWED DUMMY (CONTROL) JOINT</b> N.T.S. MAXIMUM SPACING IS 15' CTRS. (TYP.)</p>	<p><b>CONSTRUCTION JOINT</b> N.T.S.</p>
<p><b>3" AND LARGER COMPOUND WATER METER</b> CITY OF TYLER STANDARD DETAIL APPROVED: <i>[Signature]</i> UTILITIES ENGINEER REVISION DATE: 8/2/11</p>	<p><b>PAVEMENT REPAIR</b> CITY OF TYLER STANDARD DETAIL APPROVED: <i>[Signature]</i> UTILITIES ENGINEER REVISION DATE: 8/2/11</p>	<p><b>4" CONCRETE DETAIL</b> CITY OF TYLER STANDARD DETAIL APPROVED: <i>[Signature]</i> UTILITIES ENGINEER REVISION DATE: 8/2/11</p>	<p><b>TESTING REQUIREMENTS</b></p> <p><b>SOILS:</b> SUBGRADE: * PROOF ROLL AND REPAIR AS NEEDED * COMPACT TO 95% D698 AT ±2% MOISTURE * PROCTORS AS NEEDED 1 DENSITY EVERY 10,000 SQUARE FEET</p> <p><b>BASE:</b> * PROOF ROLL AND REPAIR AS NEEDED * SELECT FILL (AS RECOMMENDED BY DESIGN) * COMPACT TO 95% D698 AT ±2% MOISTURE (OR AS RECOMMENDED BY DESIGN) * PROCTORS AS NEEDED 1 DENSITY EVERY 10,000 SQUARE FEET</p> <p><b>ASPHALT:</b> TESTING IS BASED ON ~ 600 TONS PER DAY OF PLACEMENT (I.E. 1 LOT = 600 TONS), SMALL DAYS PLACEMENT (UNDER 200 TONS) AS DIRECTED BY CITY OR ENGINEER. * TXDOT ITEM 340 * 4 CORES PER DAY MUST BE 90% OC PERFORMED BY CONTRACTOR. CORES TO BE CUT BY CONTRACTOR AND DELIVERED TO LAB FOR TESTING * 1 EXTRACTION / GRADATION PER DAY (MAY BE PROVIDED BY THE ASPHALT PLANT IF AGREEMENT IS MADE WITH CITY) * 1 SET OF PATTIES PER DAY (MAY BE PROVIDED BY THE ASPHALT PLANT IF AGREEMENT IS MADE WITH CITY) * 1 RICE PER DAY (MAY BE PROVIDED BY THE ASPHALT PLANT IF AGREEMENT IS MADE WITH CITY)</p> <p><b>CONCRETE:</b> MISC. CONCRETE (SIDEWALKS, CURB AND GUTTER, ETC): * SLUMP 4" MAXIMUM * AIR 5% ±1% * 1 SET OF 4 CYLINDERS PER DAY'S PRODUCTION (7, 28, 28, SP)</p> <p><b>CONCRETE PAVING:</b> * SLUMP 4" MAXIMUM * AIR 5% ±1% * 1 SET OF 4 CYLINDERS EVERY 150 CUBIC YARDS OR PER DAY'S PRODUCTION (7, 28, 28, SP)</p>
<p><b>DOUBLE CHECK DETECTOR ASSEMBLY</b> CITY OF TYLER STANDARD DETAIL APPROVED: <i>[Signature]</i> UTILITIES ENGINEER REVISION DATE: 8/2/11</p>	<p><b>ADJUSTMENTS TO FINISHED GRADE</b> CITY OF TYLER STANDARD DETAIL APPROVED: <i>[Signature]</i> UTILITIES ENGINEER REVISION DATE: 5/23/13</p>	<p><b>TESTING REQUIREMENTS FOR PAVING</b> CITY OF TYLER STANDARD DETAIL APPROVED: <i>[Signature]</i> UTILITIES ENGINEER REVISION DATE: 11/3/17</p>	<p><b>DRAWN:</b> JHD <b>CHECKED:</b> WHS <b>DATE:</b> 10/11/2022 <b>SCALE:</b> AS SHOWN <b>JOB NO.:</b> 22-069</p>



## INSTALLATION AND OWNER'S INSTRUCTIONS




888-USA-GOAL  
goalsetter.com

### Signature Series Internal Jack Adjustable Height Goal System

- MVP
- Captain

#### TABLE OF CONTENTS


Safety Instructions	2
Goal Specifications	3
Determine Installation Location	3
Ground Anchor Installation	4
Pole Assembly	5
Extension Arm Attachments	6
Backboard Attachment	7
Goal Alignment	8
Rim Attachment	9
Height Indicator Adjustment	10
Ready to Play	11
Warranties	Back Cover

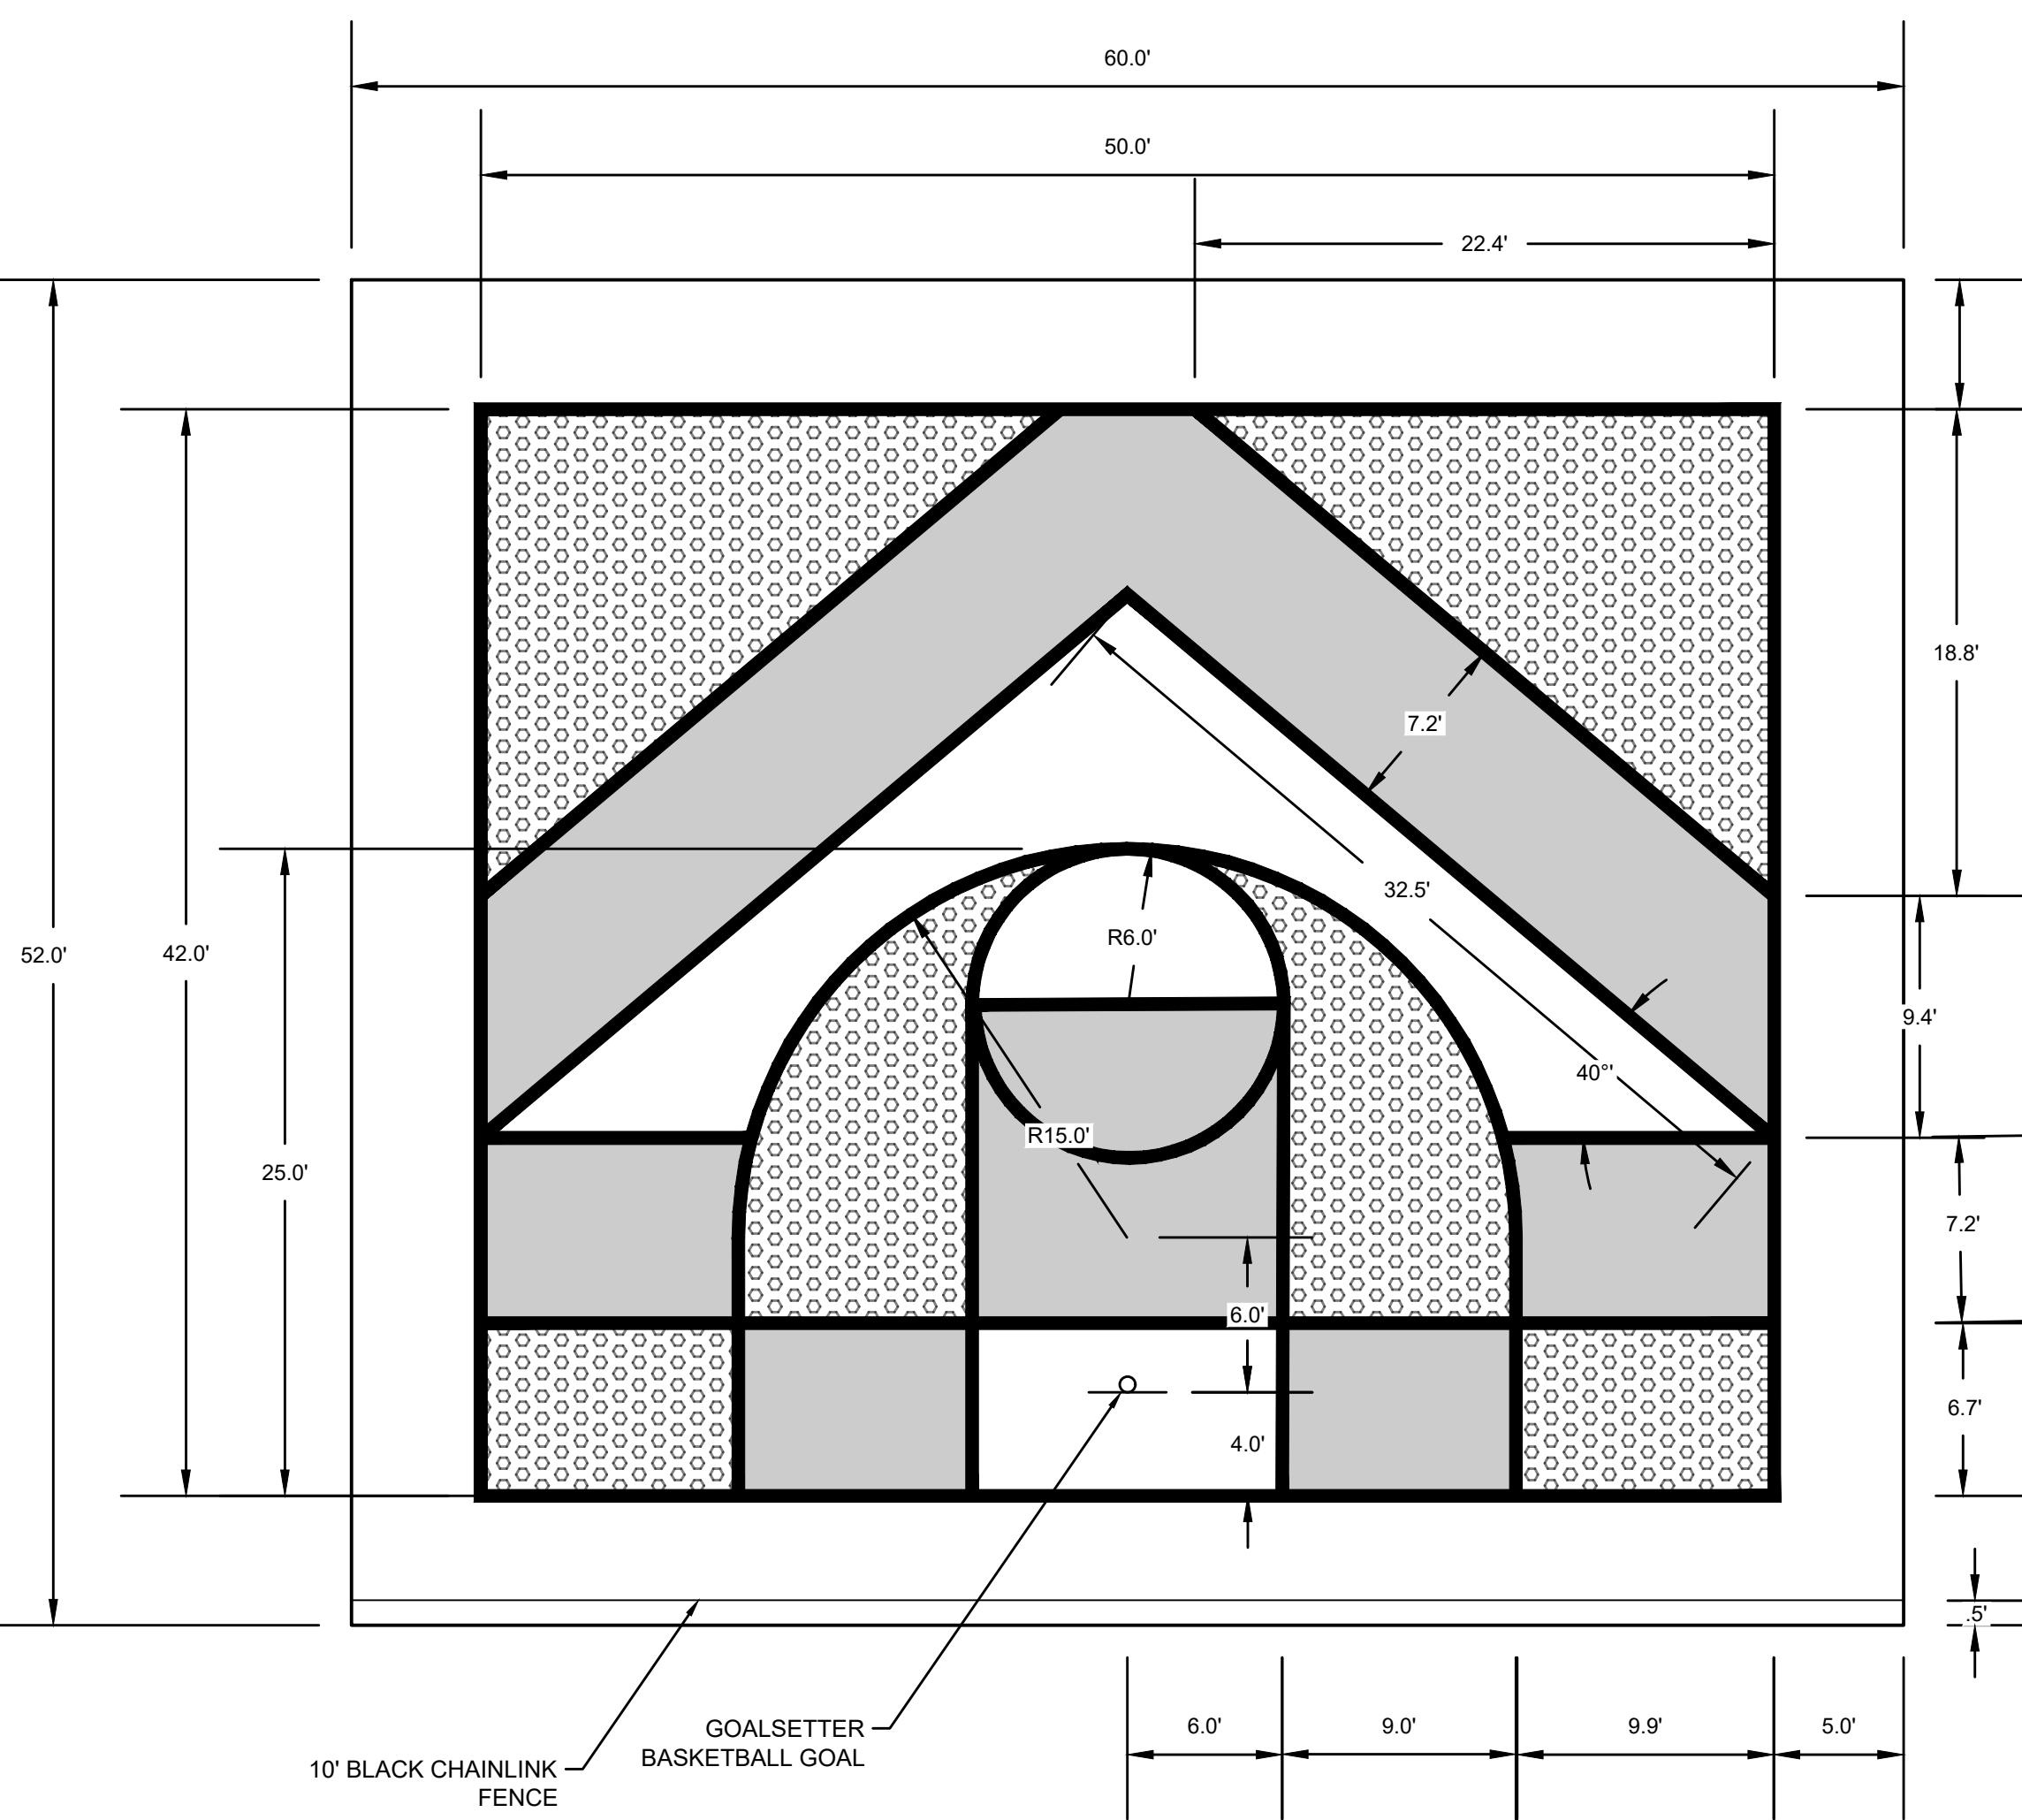

SURFACING COLOR NOTE:  
 LIGHT BLUE ± 803 SF  
 PURPLE ± 726 SF  
 GRAY ± 365 SF  
 ORANGE (STRIPING) ± 534 LF

NOTE:  
 SEE SITE PLAN FOR HORIZONTAL CONTROL  
 SURFACING AND STRIPING COLORS TO BE SUBMITTED AND APPROVED BY CITY AND CONSULTANT.  
 SURFACING TO BE PLEXI-PAVE - PLEXI STANDARD, INSTALLED PER MANUFACTURER'S RECOMMENDATIONS


REVISIONS:

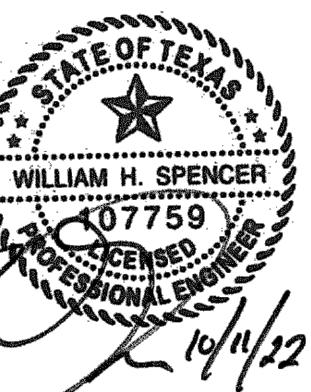

WHS  
PLANNING & DESIGN, LLC  
212 West Ninth Street, Tyler, Texas 75701  
903.597.6606

#### Goal Specifications

	MVP	Captain
Pole Size:	6" x 6"	6" x 6"
Backboard Size:	42" x 72"	38" x 60"
Weight w/Acrylic:	525 lbs.	510 lbs.
Weight w/Glass:	585 lbs.	560 lbs.
(A) Height Range:	6'-10"	6'-10"
(B) Extension Distance:	at 10' 51"	51"
	at 8' 54"	54"
	at 6' 48"	48"
(C) Maximum Overhang:	79"	79"
(D) Distance Rim to Backboard:	25"	25"
(E) Distance Rim to Top of Goal:	33 1/4"	29 1/4"
(F) Crank Distance:	11 1/2"	11 1/2"
(G) Crank Height:	36 1/2"	36 1/2"
(H) Offset Height:	7'-0"	7'-0"
(I) Pole Height:	10'-5"	10'-5"
(J) Offset Distance:	21"	21"
(K) Crank Turn Radius:	8"	8"

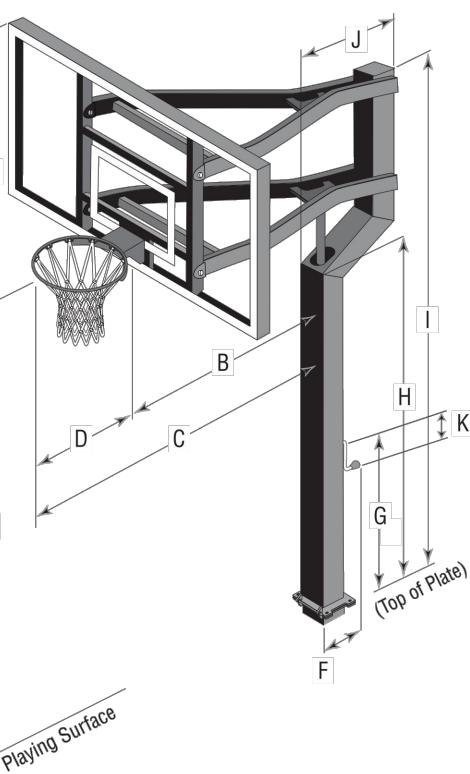

#### Determine Installation Location

Consider the following to determine where to install your Goalsetter® Basketball Goal:

- When extended, will backboard overhang obstruct driveway or other important space? Maximum overhang: 79" (2 m) from the front of the pole to the front of the rim.
- Is there room so vehicles backing out of driveway do not strike backboard or rim?
- Will court markings be used?
- How much playing surface is needed?
- How much playing surface will be under the backboard? (Having the edge of the playing surface directly underneath the backboard can result in trip hazards and unpredictable ball action following a shot. Try to have as much playing surface as possible behind the backboard.)
- Other functions of playing surface (driveway, playground, etc.)



- Will the goal be at least 20 ft. (7 m) from any overhead power lines? (No overhead power lines should be within a 20 ft. (7 m) radius of the goal.)
- Will the ground anchor for the goal avoid underground power, gas, telephone, water and other utility lines? (See 811 One Call Warning box on page 2 for more information or call your local utility company.)

#### Required Tools and Materials:

- Spade
- Shovel
- Tape Measure
- Level
- Hoe
- Water
- Rubber Mallet
- Steel Punch
- Step Ladder
- Wheelbarrow
- Cement Trowel
- Stir Rod
- Auger/Post Hole Digger (optional)
- 10-14, 60 lb Bags of Dry Concrete Mix (or 1/4-1/2 yard of ready mix concrete)
- 1/2" Drive Torque Wrench
- Phillips Screwdriver
- 9/16" & 3/4" Wrenches and Sockets

#### Court Markings

(Reference Only):  
 Regulation Court Lengths  
 High School: 84'  
 College & Professional: 94'

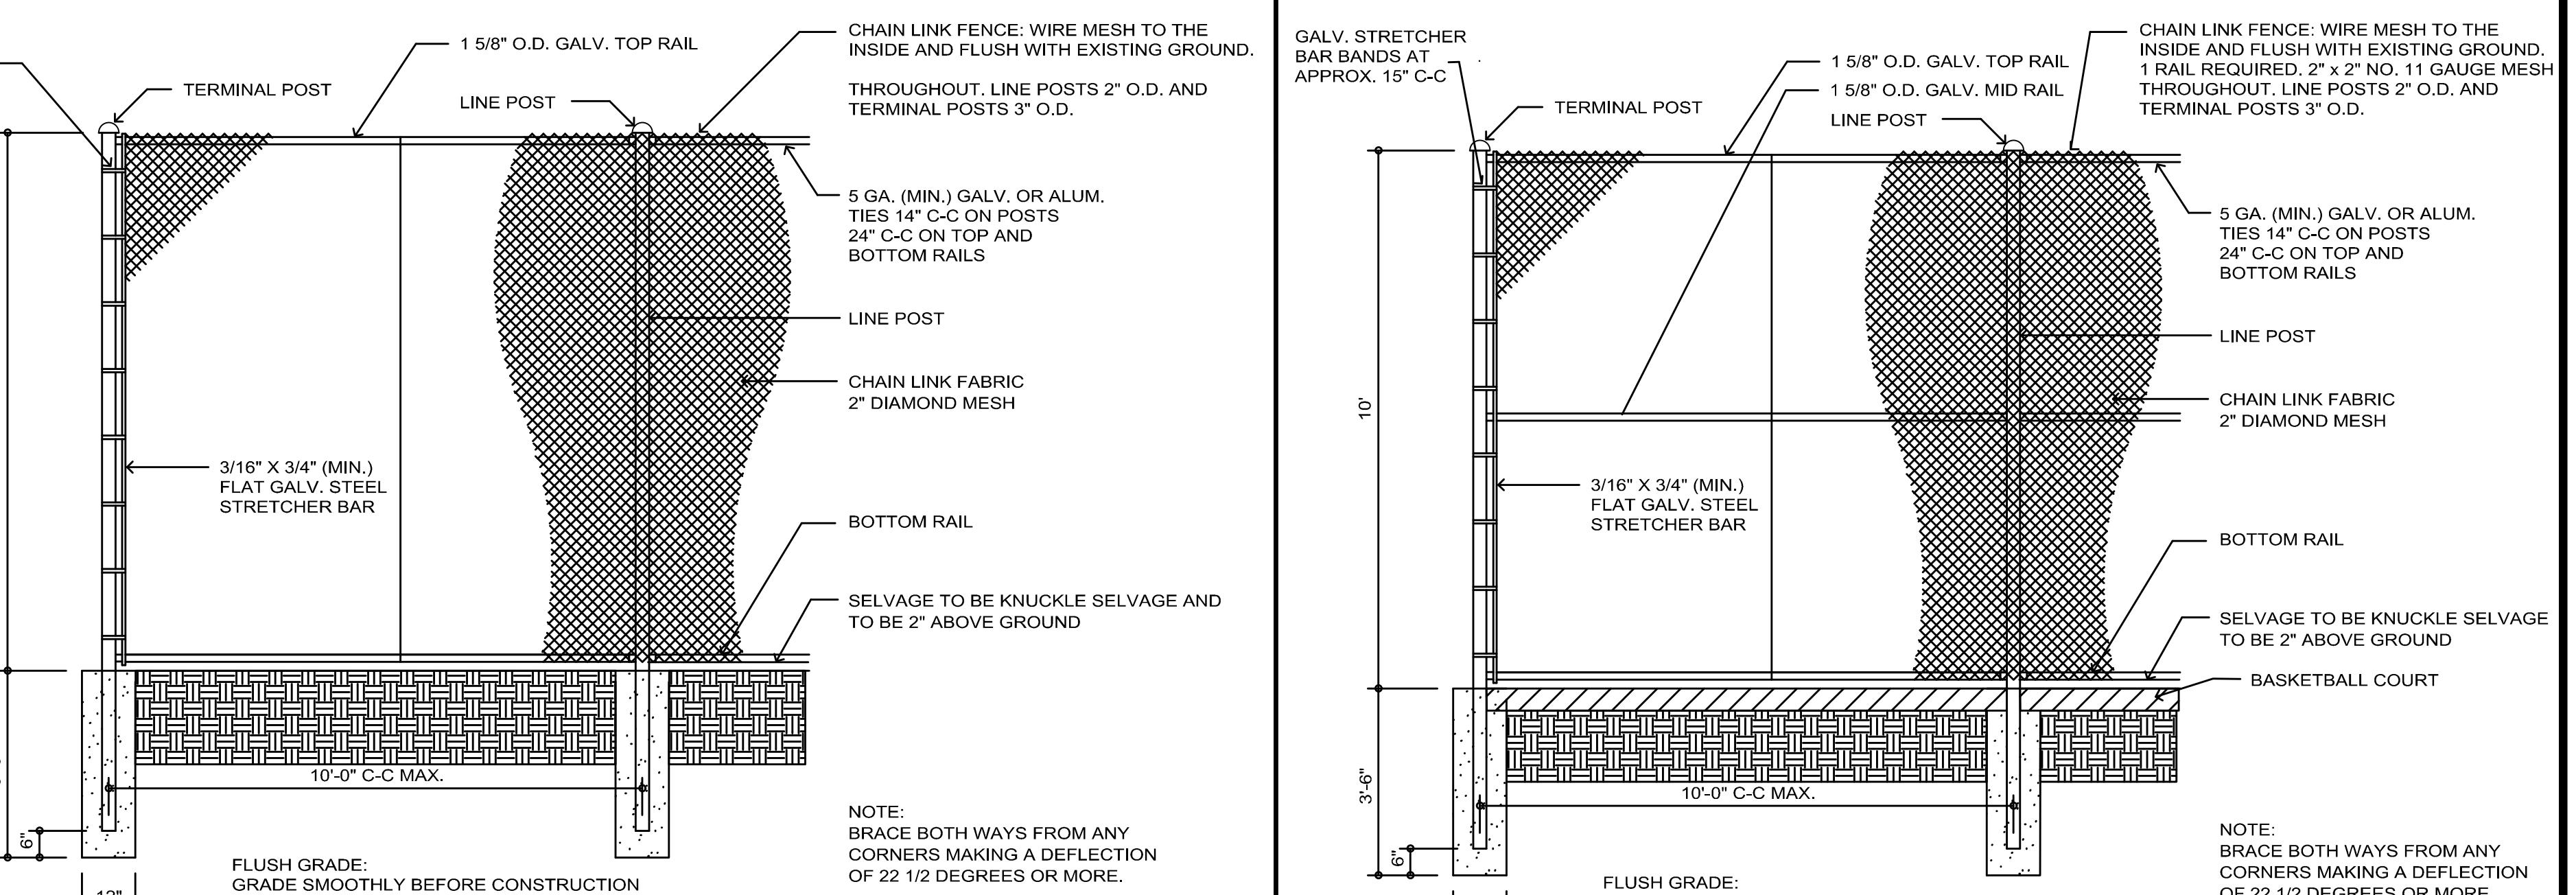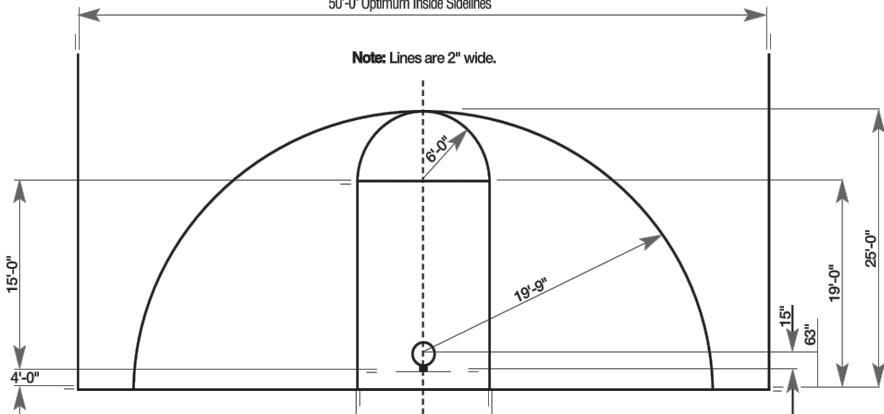

TYPICAL TERMINAL SECTION  
(6' EQUIPMENT FENCE)


TYPICAL TERMINAL SECTION  
(10' BASKETBALL FENCE)

## CONSTRUCTION DETAILS III

### P.T. COLE PARK CITY OF TYLER, TEXAS

DRAWN: MEP  
CHECKED: WHS  
DATE: 10/11/2022  
SCALE: AS SHOWN  
JOB NO.: 22-069

C16



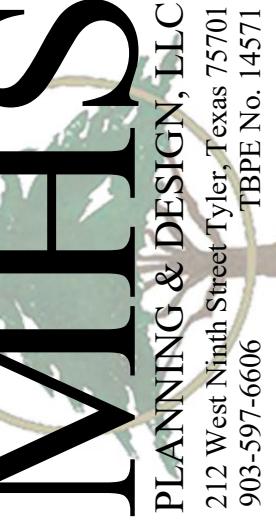


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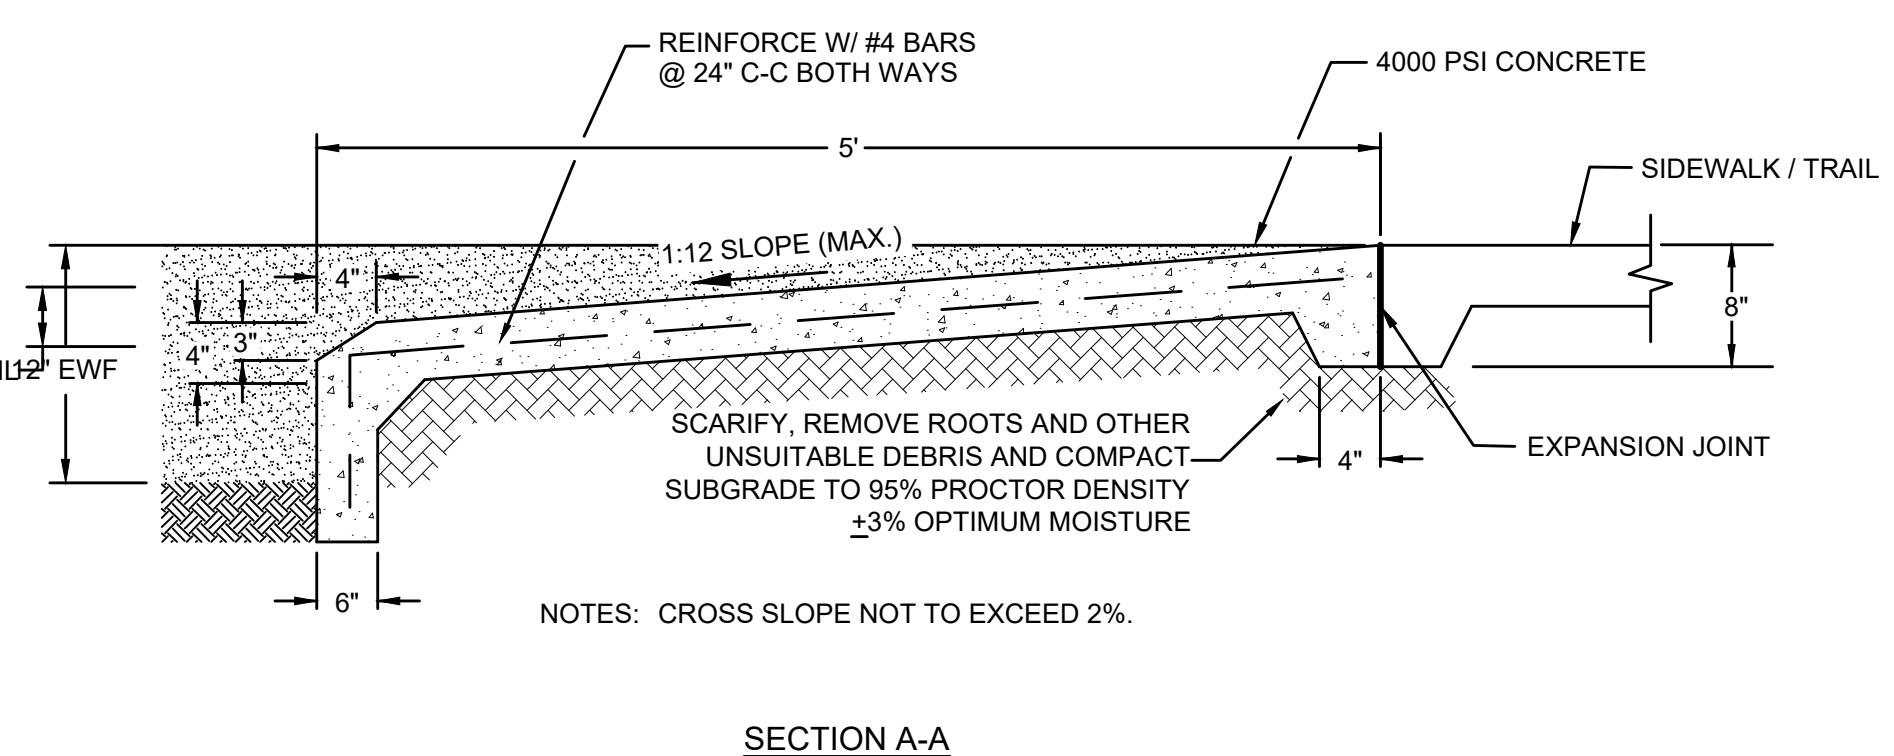
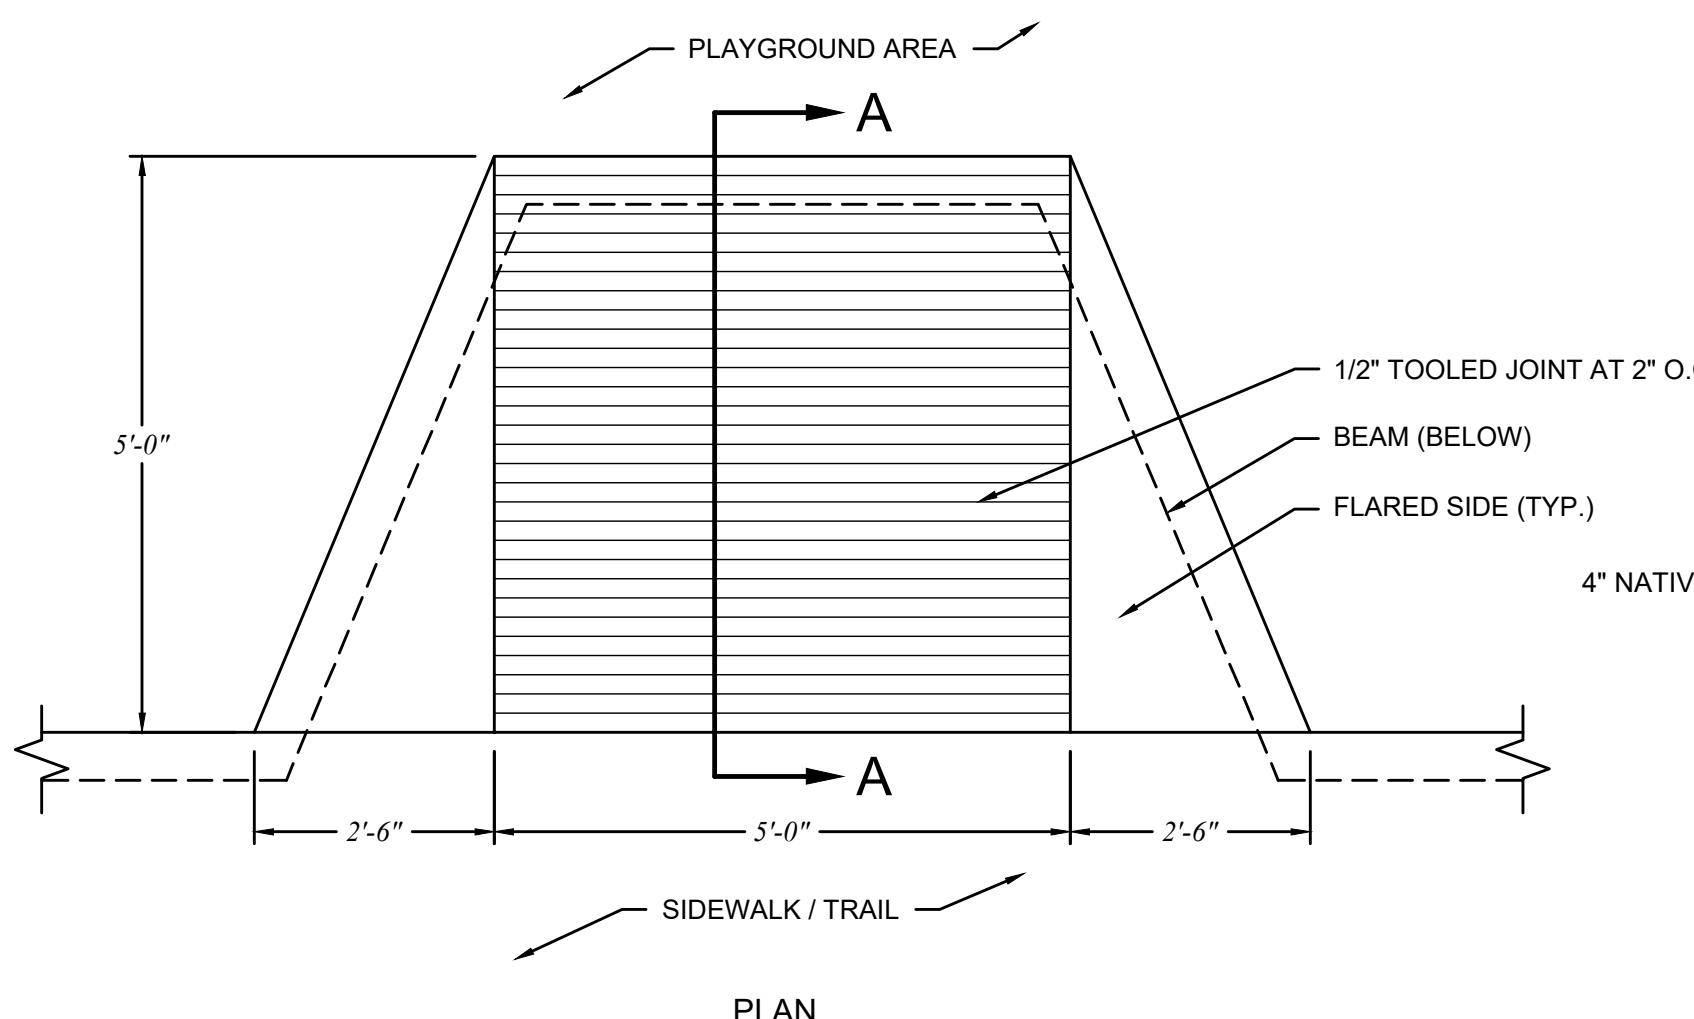
## CONSTRUCTION DETAILS IV

P.T. COLE PARK  
CITY OF TYLER, TEXAS


VERTICAL WALL  
TOOL JOINTS

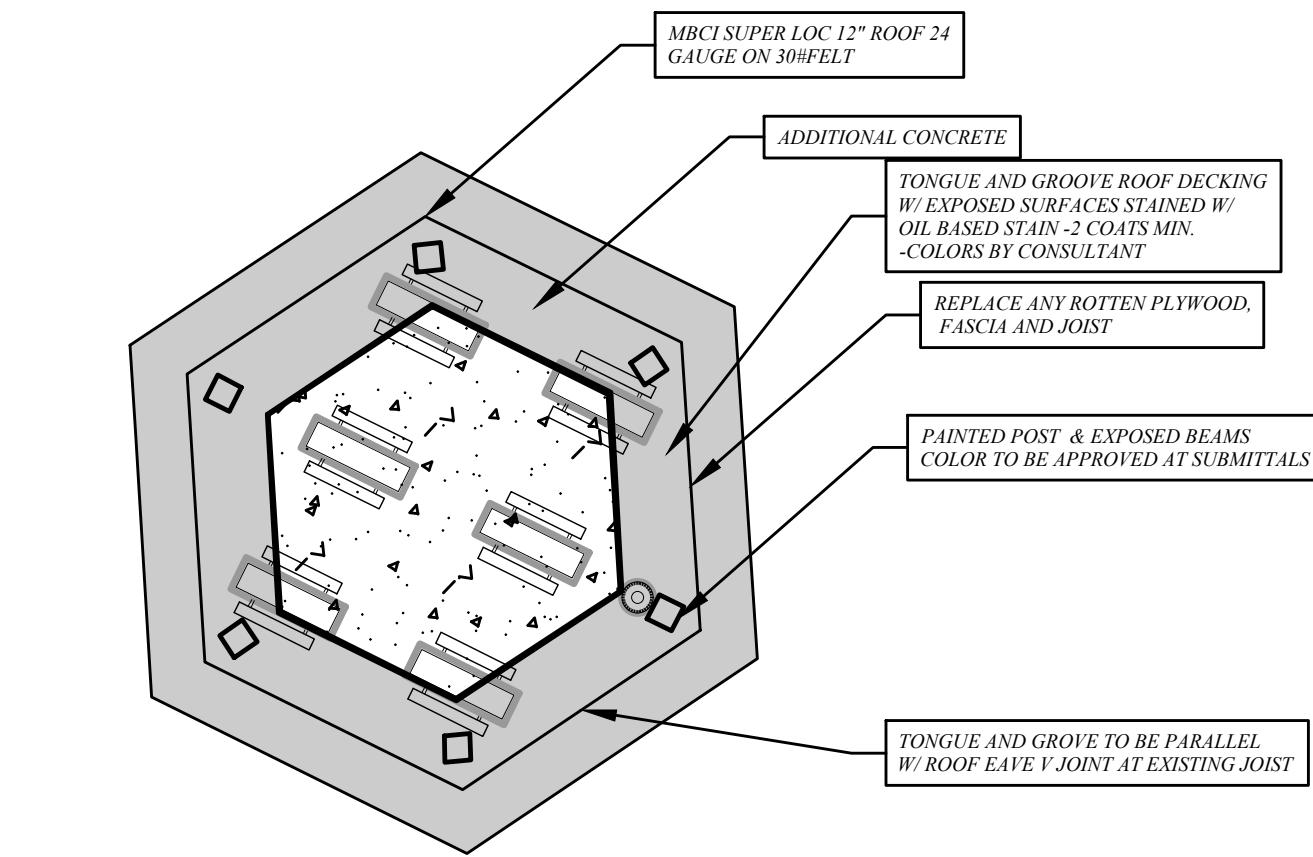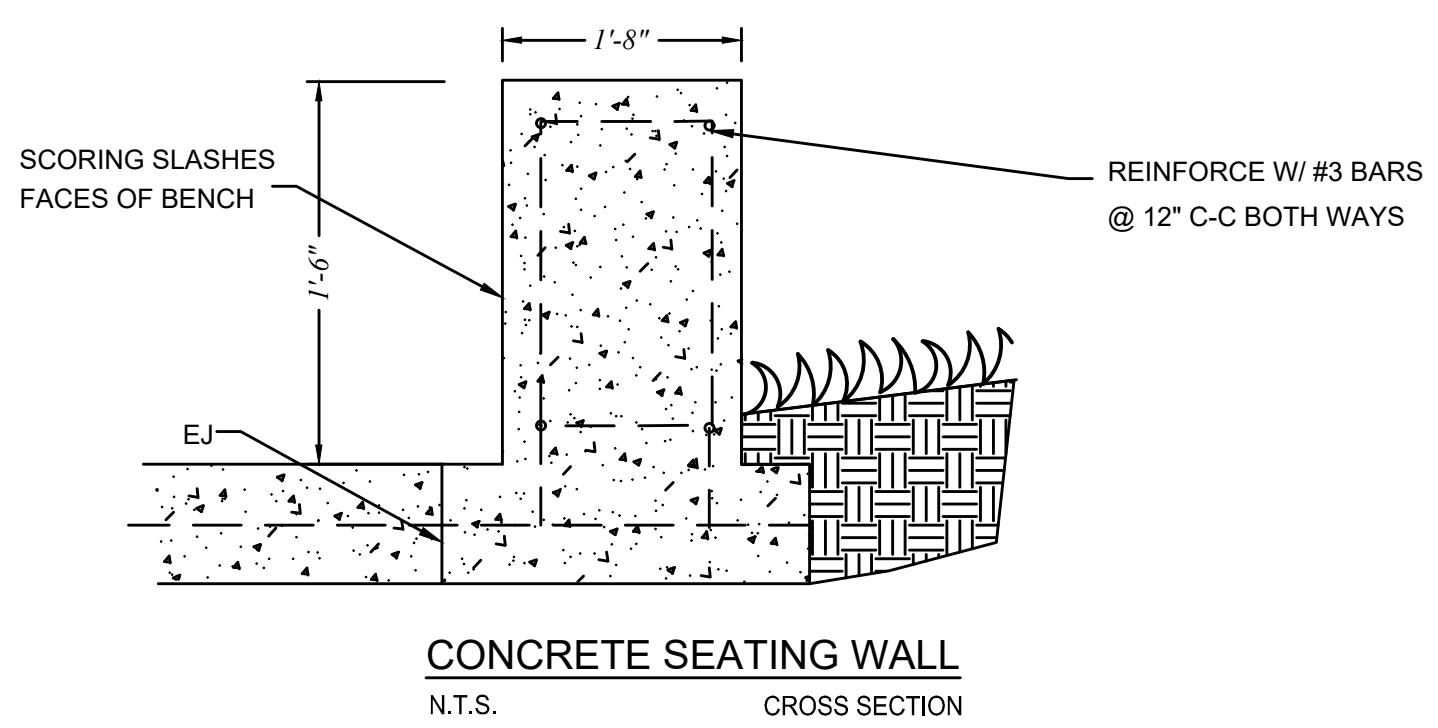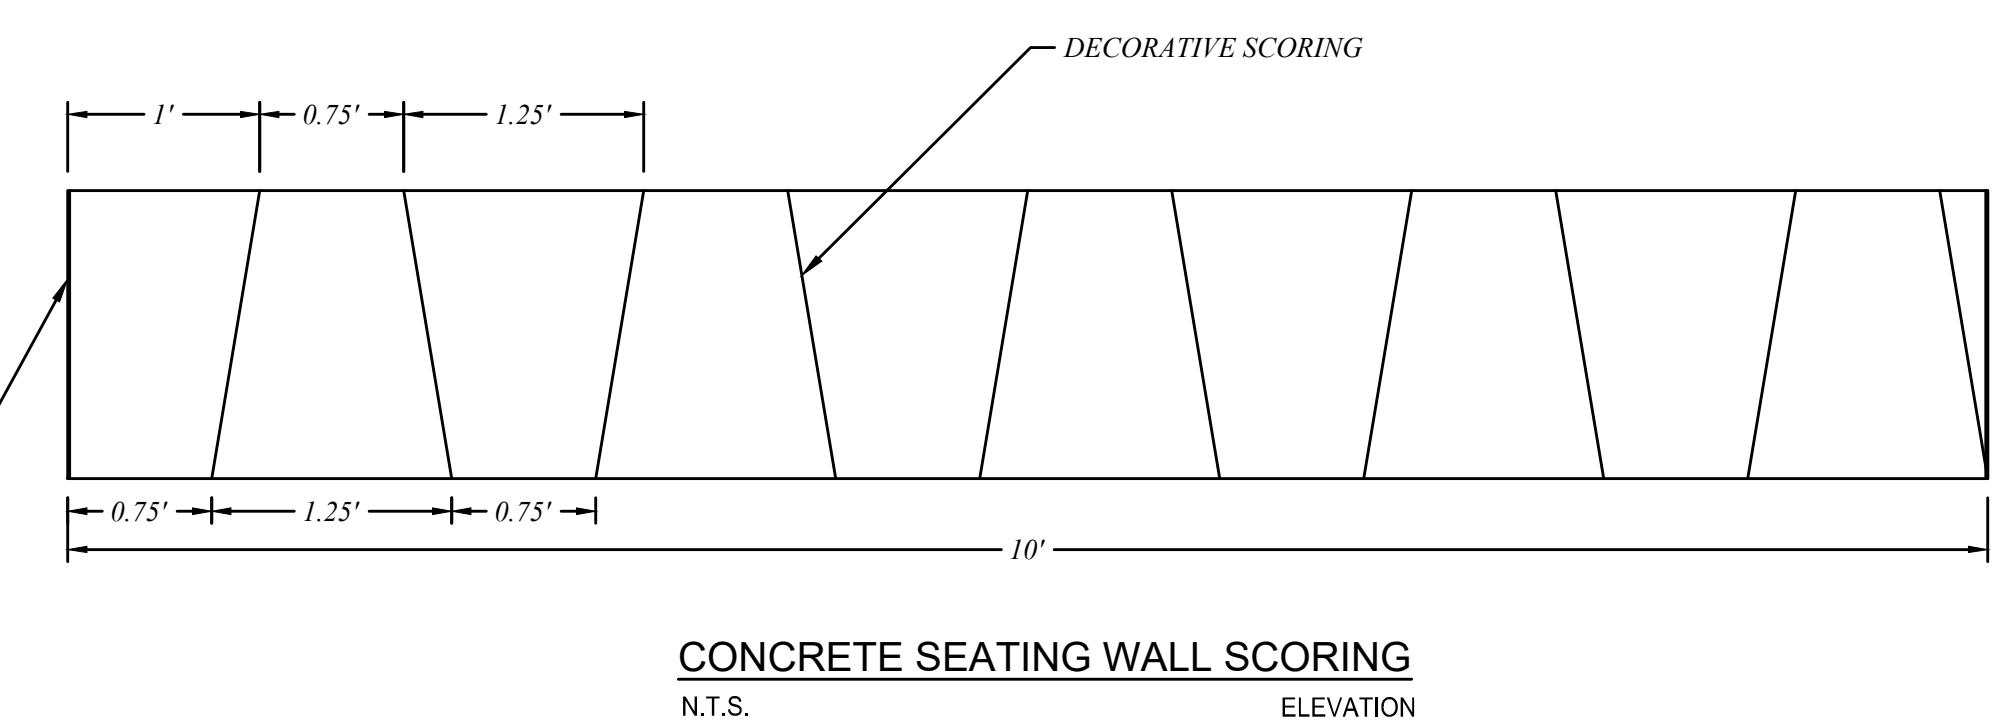


PAVILION PLAN VIEW  
N.T.S.




SECTION A-A

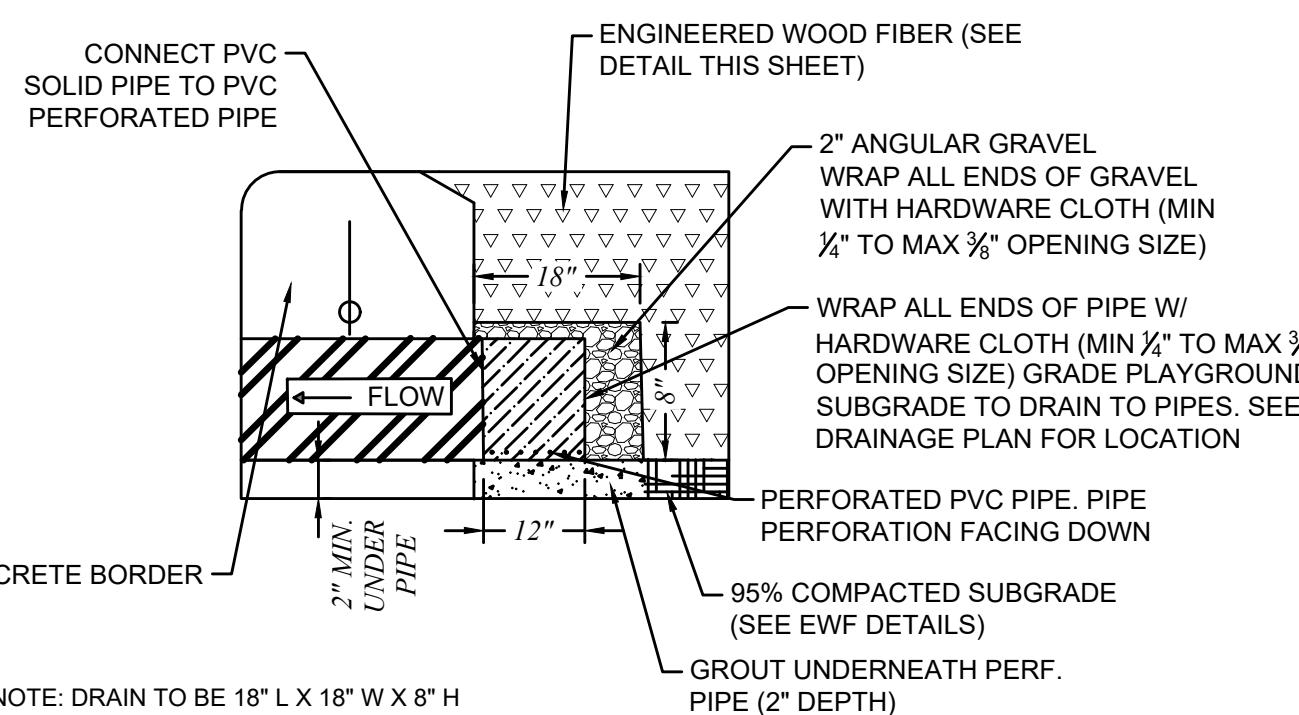


PLAYGROUND DRAIN DETAIL (ENGINEERED WOOD FIBER)  
N.T.S.

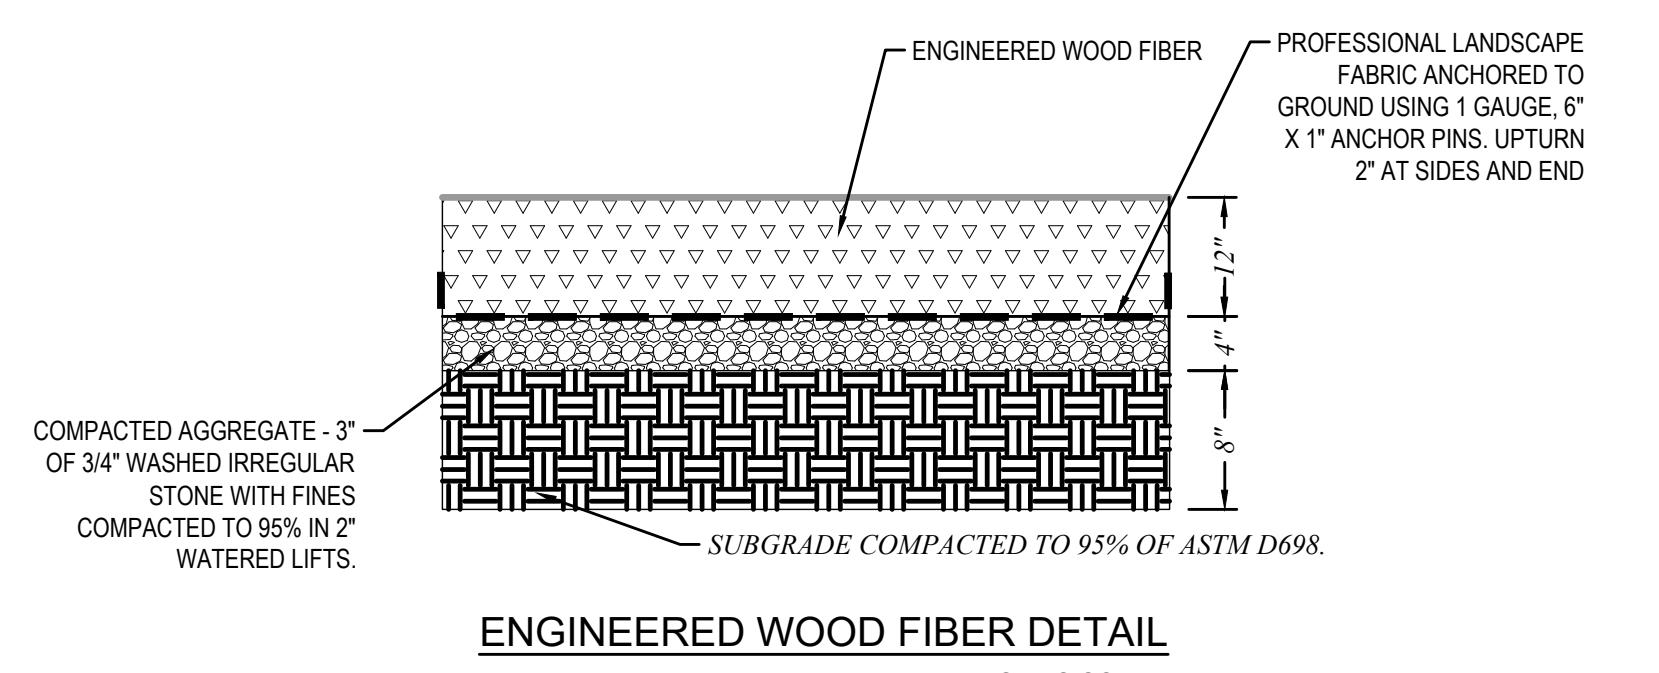


NOT TO SCALE

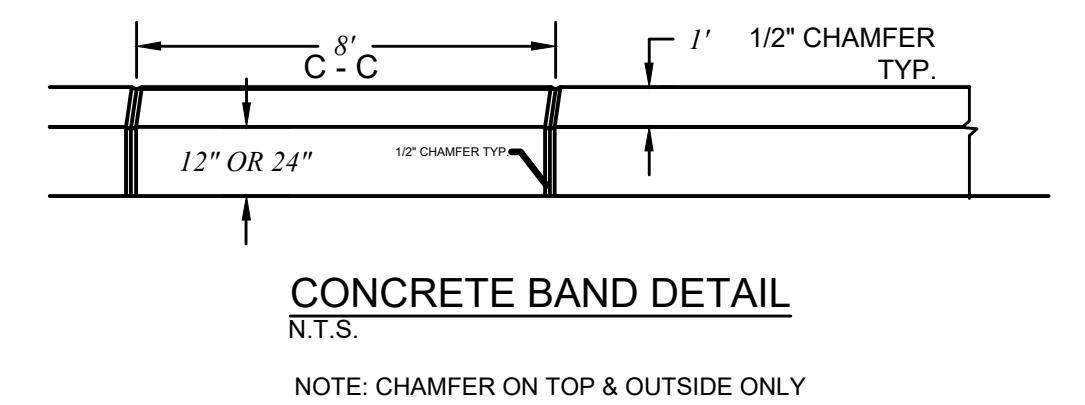


N.T.S.

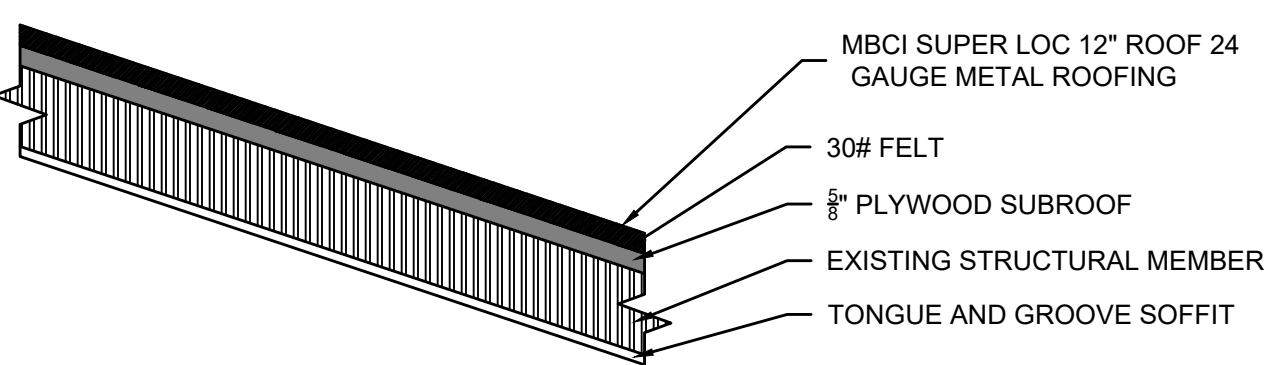

ROOFING DETAIL  
N.T.S.

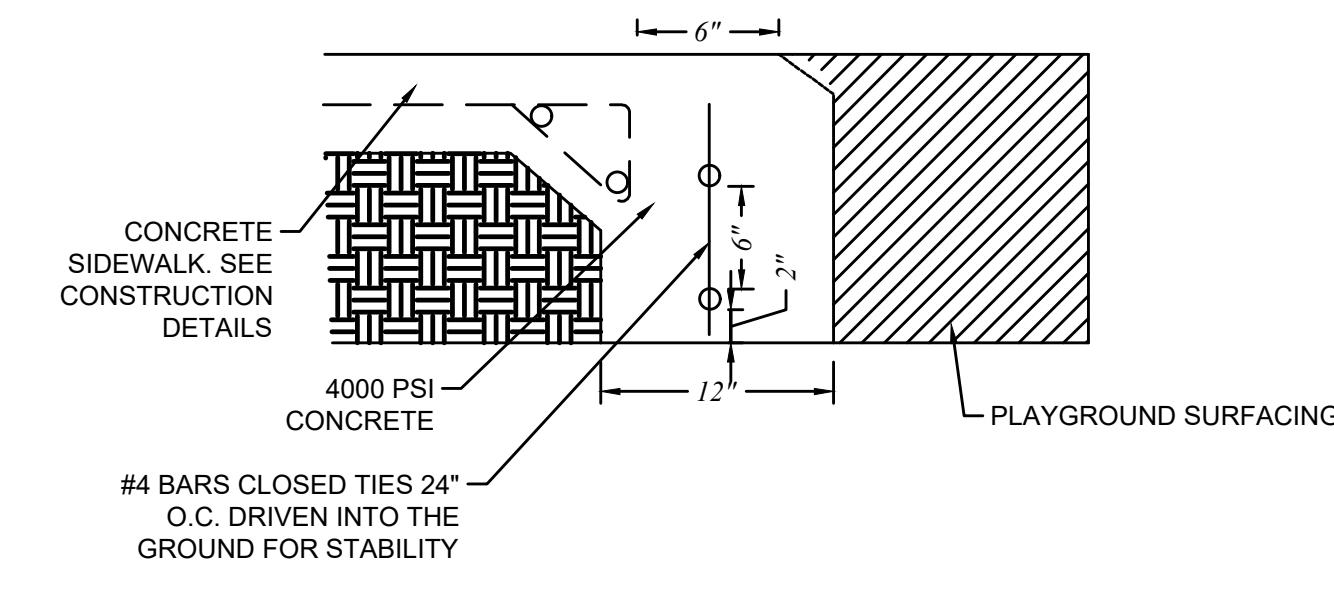

CONCRETE BAND W/ SIDEWALK  
N.T.S.

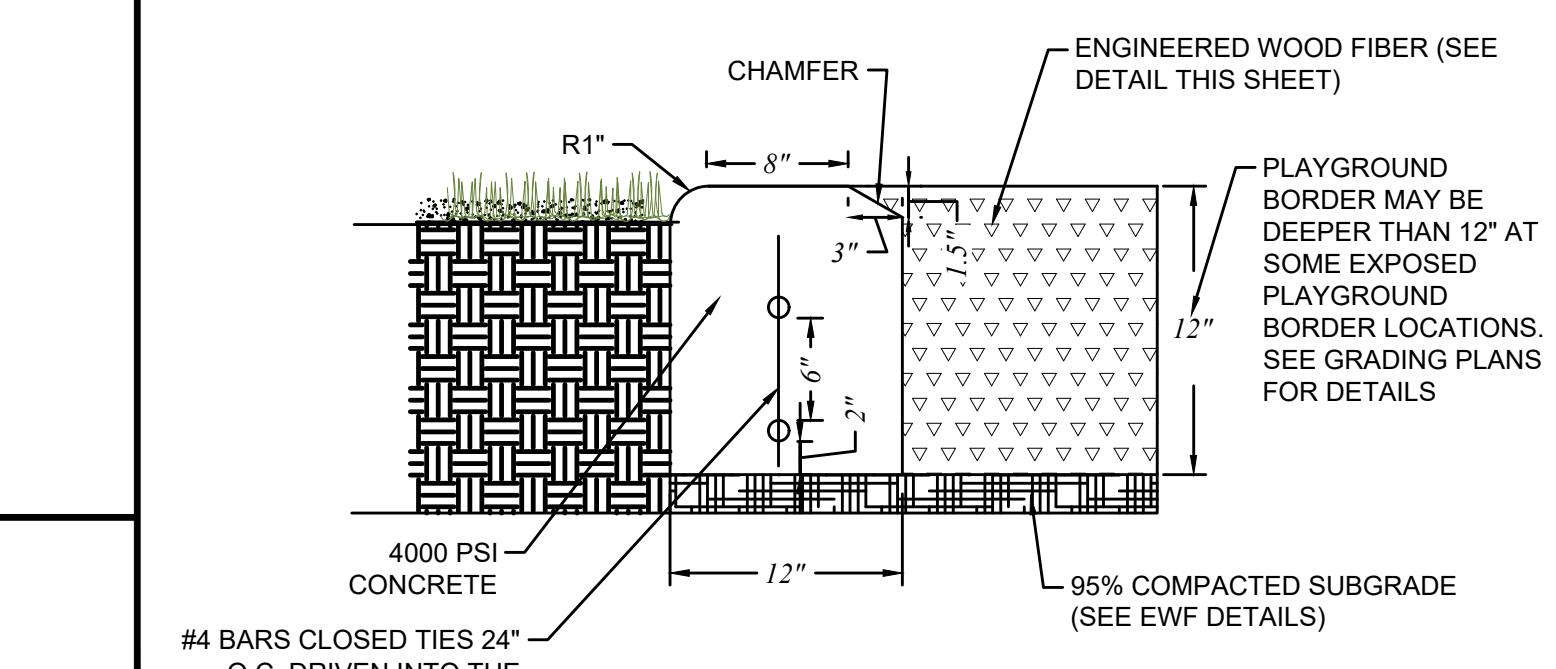

12" CONCRETE BAND DETAIL (ENGINEERED WOOD FIBER)  
N.T.S.


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DATE: 10/11/2022  
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JOB NO.: 22-069



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# CONSTRUCTION DETAILS V


P.T. COLE PARK  
CITY OF TYLER, TEXAS

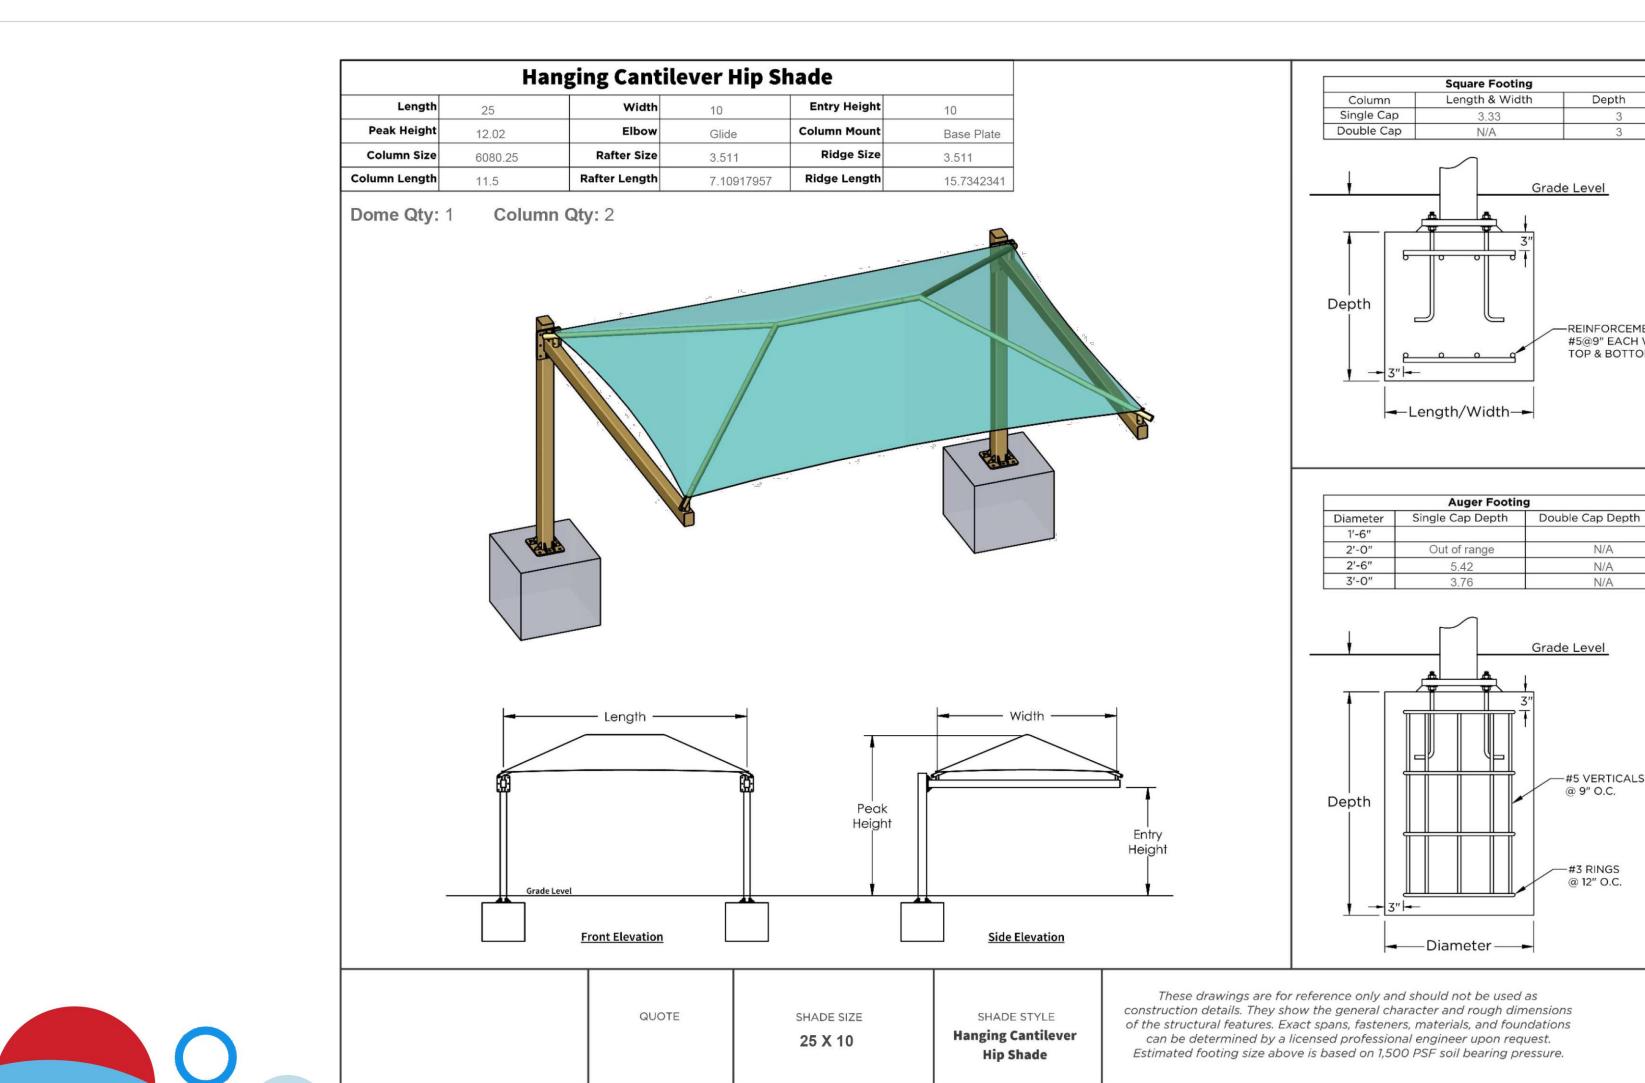

P.T. Cole Park SplashPark  
Tyler, TX


Project 28312  
Option 3  
Sheet K-1D  
Designer MZB  
Date 10/05/2022  
Drawing Name KPS-28312-3  
View Site Amenities Details  
Sales Rep Ryan Stoff

SHADE STRUCTURE (ADD ALTERNATE)

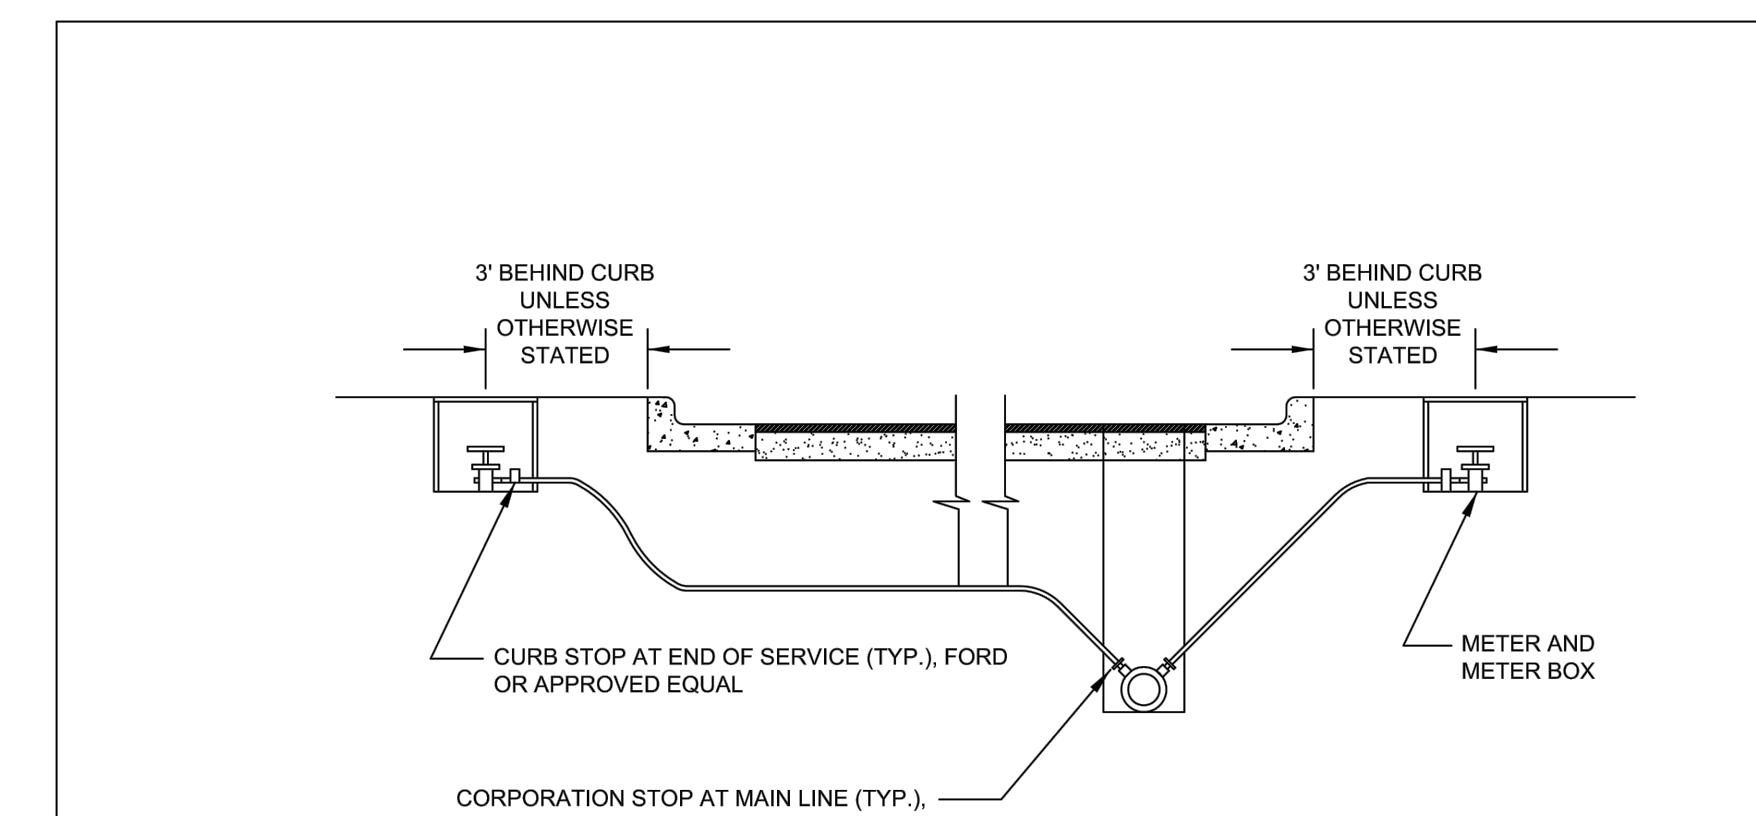

NOTES:  
1. TYPE K PIPE TO BE HELD LOW TO BEYOND PROPOSED CURB WITH A GRADUAL BEND TO WITHIN 12" OF FINISHED GRADE.  
2. EACH SERVICE LINE SHALL BE PERMANENTLY MARKED WITH A "W" ON THE CURB WHERE THE SERVICE LINE CROSSES THE CURB.  
3. METER STOPS TO REMAIN UNCOVERED UNTIL GPS COORDINATES ARE OBTAINED FOR END OF SERVICE.  
4. T-POST, PLASTIC PIPE, OR SOME OTHER SEMI-PERMANENT MARKER, PAINTED BLUE, TO BE PLACED AT END OF SERVICE LINE UNTIL METER AND BOX CAN BE INSTALLED.  
5. ALL FITTINGS ARE REQUIRED TO BE "NO LEAD".


CITY OF TYLER STANDARD DETAIL      WATER SERVICE INSTALLATION      APPROVED: *[Signature]*  
REVISION DATE: 11/17      UTILITIES ENGINEER: *[Signature]*

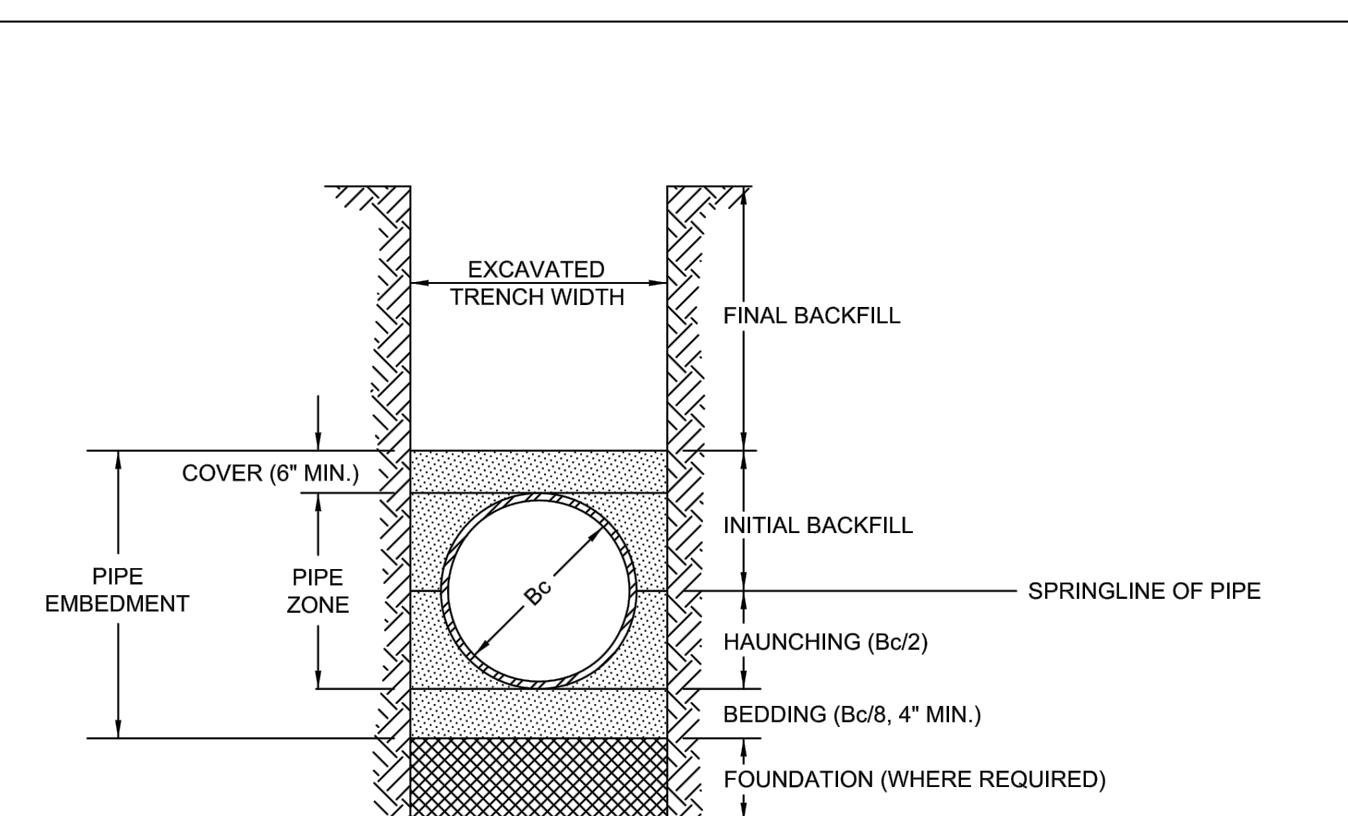



NOTES:  
1. MATERIAL USED FOR BEDDING, HAUNCHING, INITIAL BACKFILL AND COVER SHALL ALL BE THE SAME MATERIAL AND SHALL BE IN ACCORDANCE WITH EMBEDMENT SPECIFICATION IN THE CITY OF TYLER STANDARD SPECIFICATION FOR PVC WATER OR PVC GRAVITY SEWER PIPE.

CITY OF TYLER STANDARD DETAIL      TRENCH CROSS-SECTION FOR PVC PIPE      APPROVED: *[Signature]*  
REVISION DATE: 8/2/11      UTILITIES ENGINEER: *[Signature]*

ALL CONCRETE SHALL HAVE A 28 DAY COMPRESSIVE STRENGTH OF 5000 psi.  
REINFORCING STEEL SHALL COMPLY WITH ASTM A51 GRADE 60, 70, 75 GRADE OR A407 GRADE 70. BAR BENDING AND PLACEMENT SHALL COMPLY WITH THE LATEST ACI STANDARDS.  
STANDARD STRUCTURAL DESIGN IS BASED ON THE ADAMSON DESIGN METHOD.  
WATER TABLE IS AT 3'-0" BELOW GRADE FOR STANDARD STRUCTURAL DESIGN.  
THE STANDARD DESIGN IS BASED ON THE TOP AT GRADE AND THE BASE AT 8'-0" MAX. BELOW GRADE.  
THE STRUCTURE SHALL BE PLACED ON A COMPACTED GRANULAR BASE TO INSURE UNIFORM DISTRIBUTION OF SOIL PRESSURES.  
SPECIAL DESIGNS BASED ON OTHER LOADINGS OR DEEPER INSTALLATION DEPTHS ARE AVAILABLE ON REQUEST.  
KNOCKOUTS OR PIPE OPENINGS OR CAN BE PROVIDED IN THE SIZE AND LOCATIONS REQUIRED.

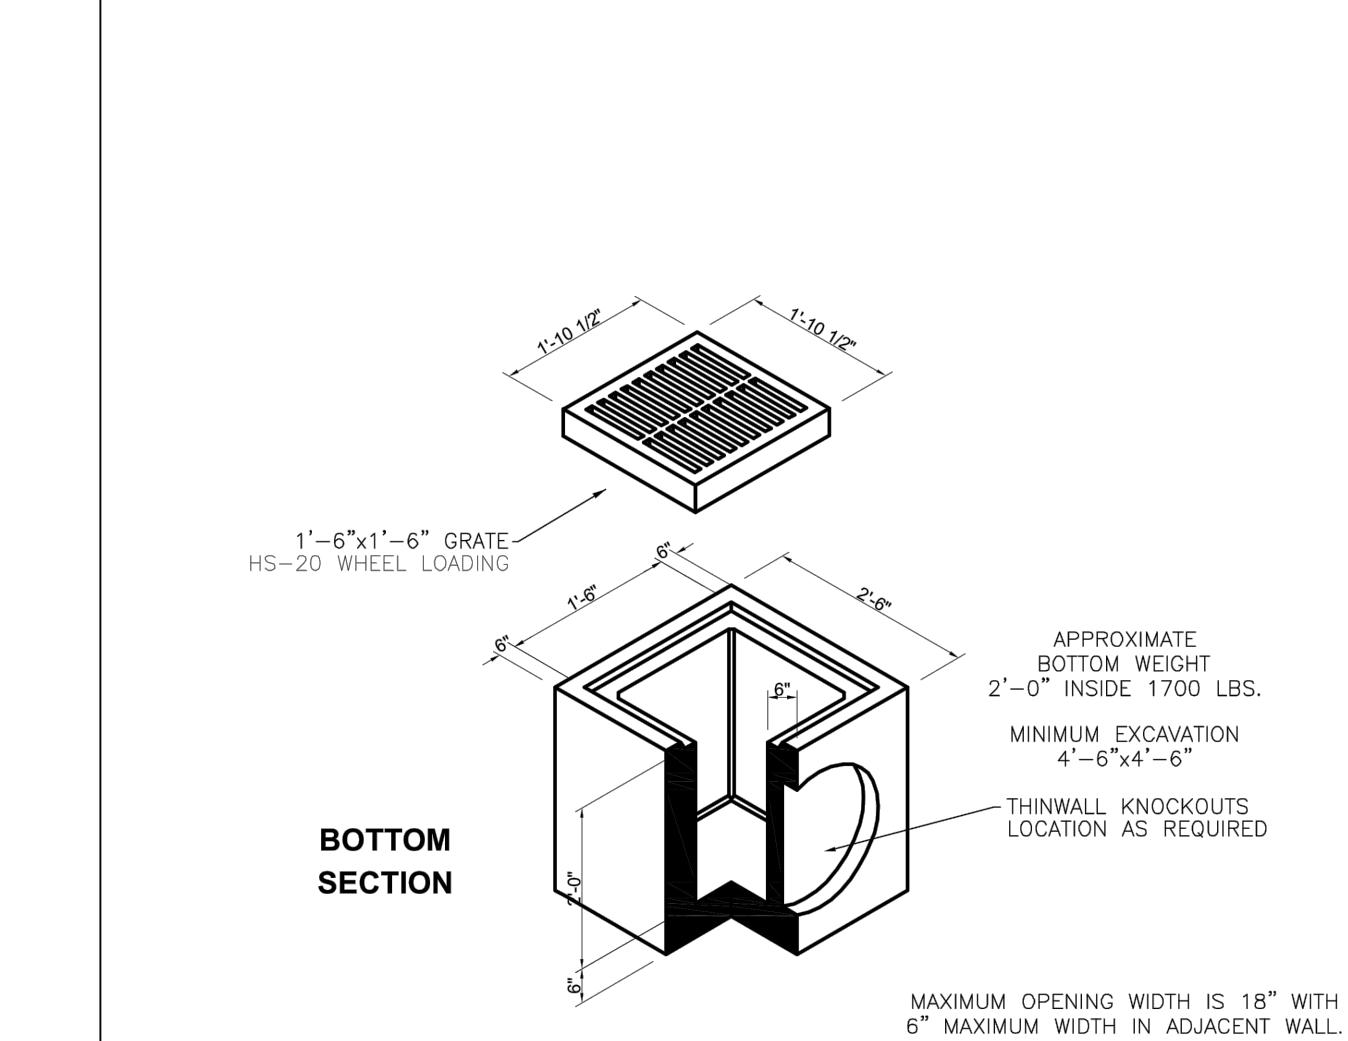

**Oldcastle Precast** GI1515  
FILE NAME: 1515GI.dwg  
ISSUE DATE: March, 2005  
Phone: (210) 923-4523 Fax: (210) 921-0473  
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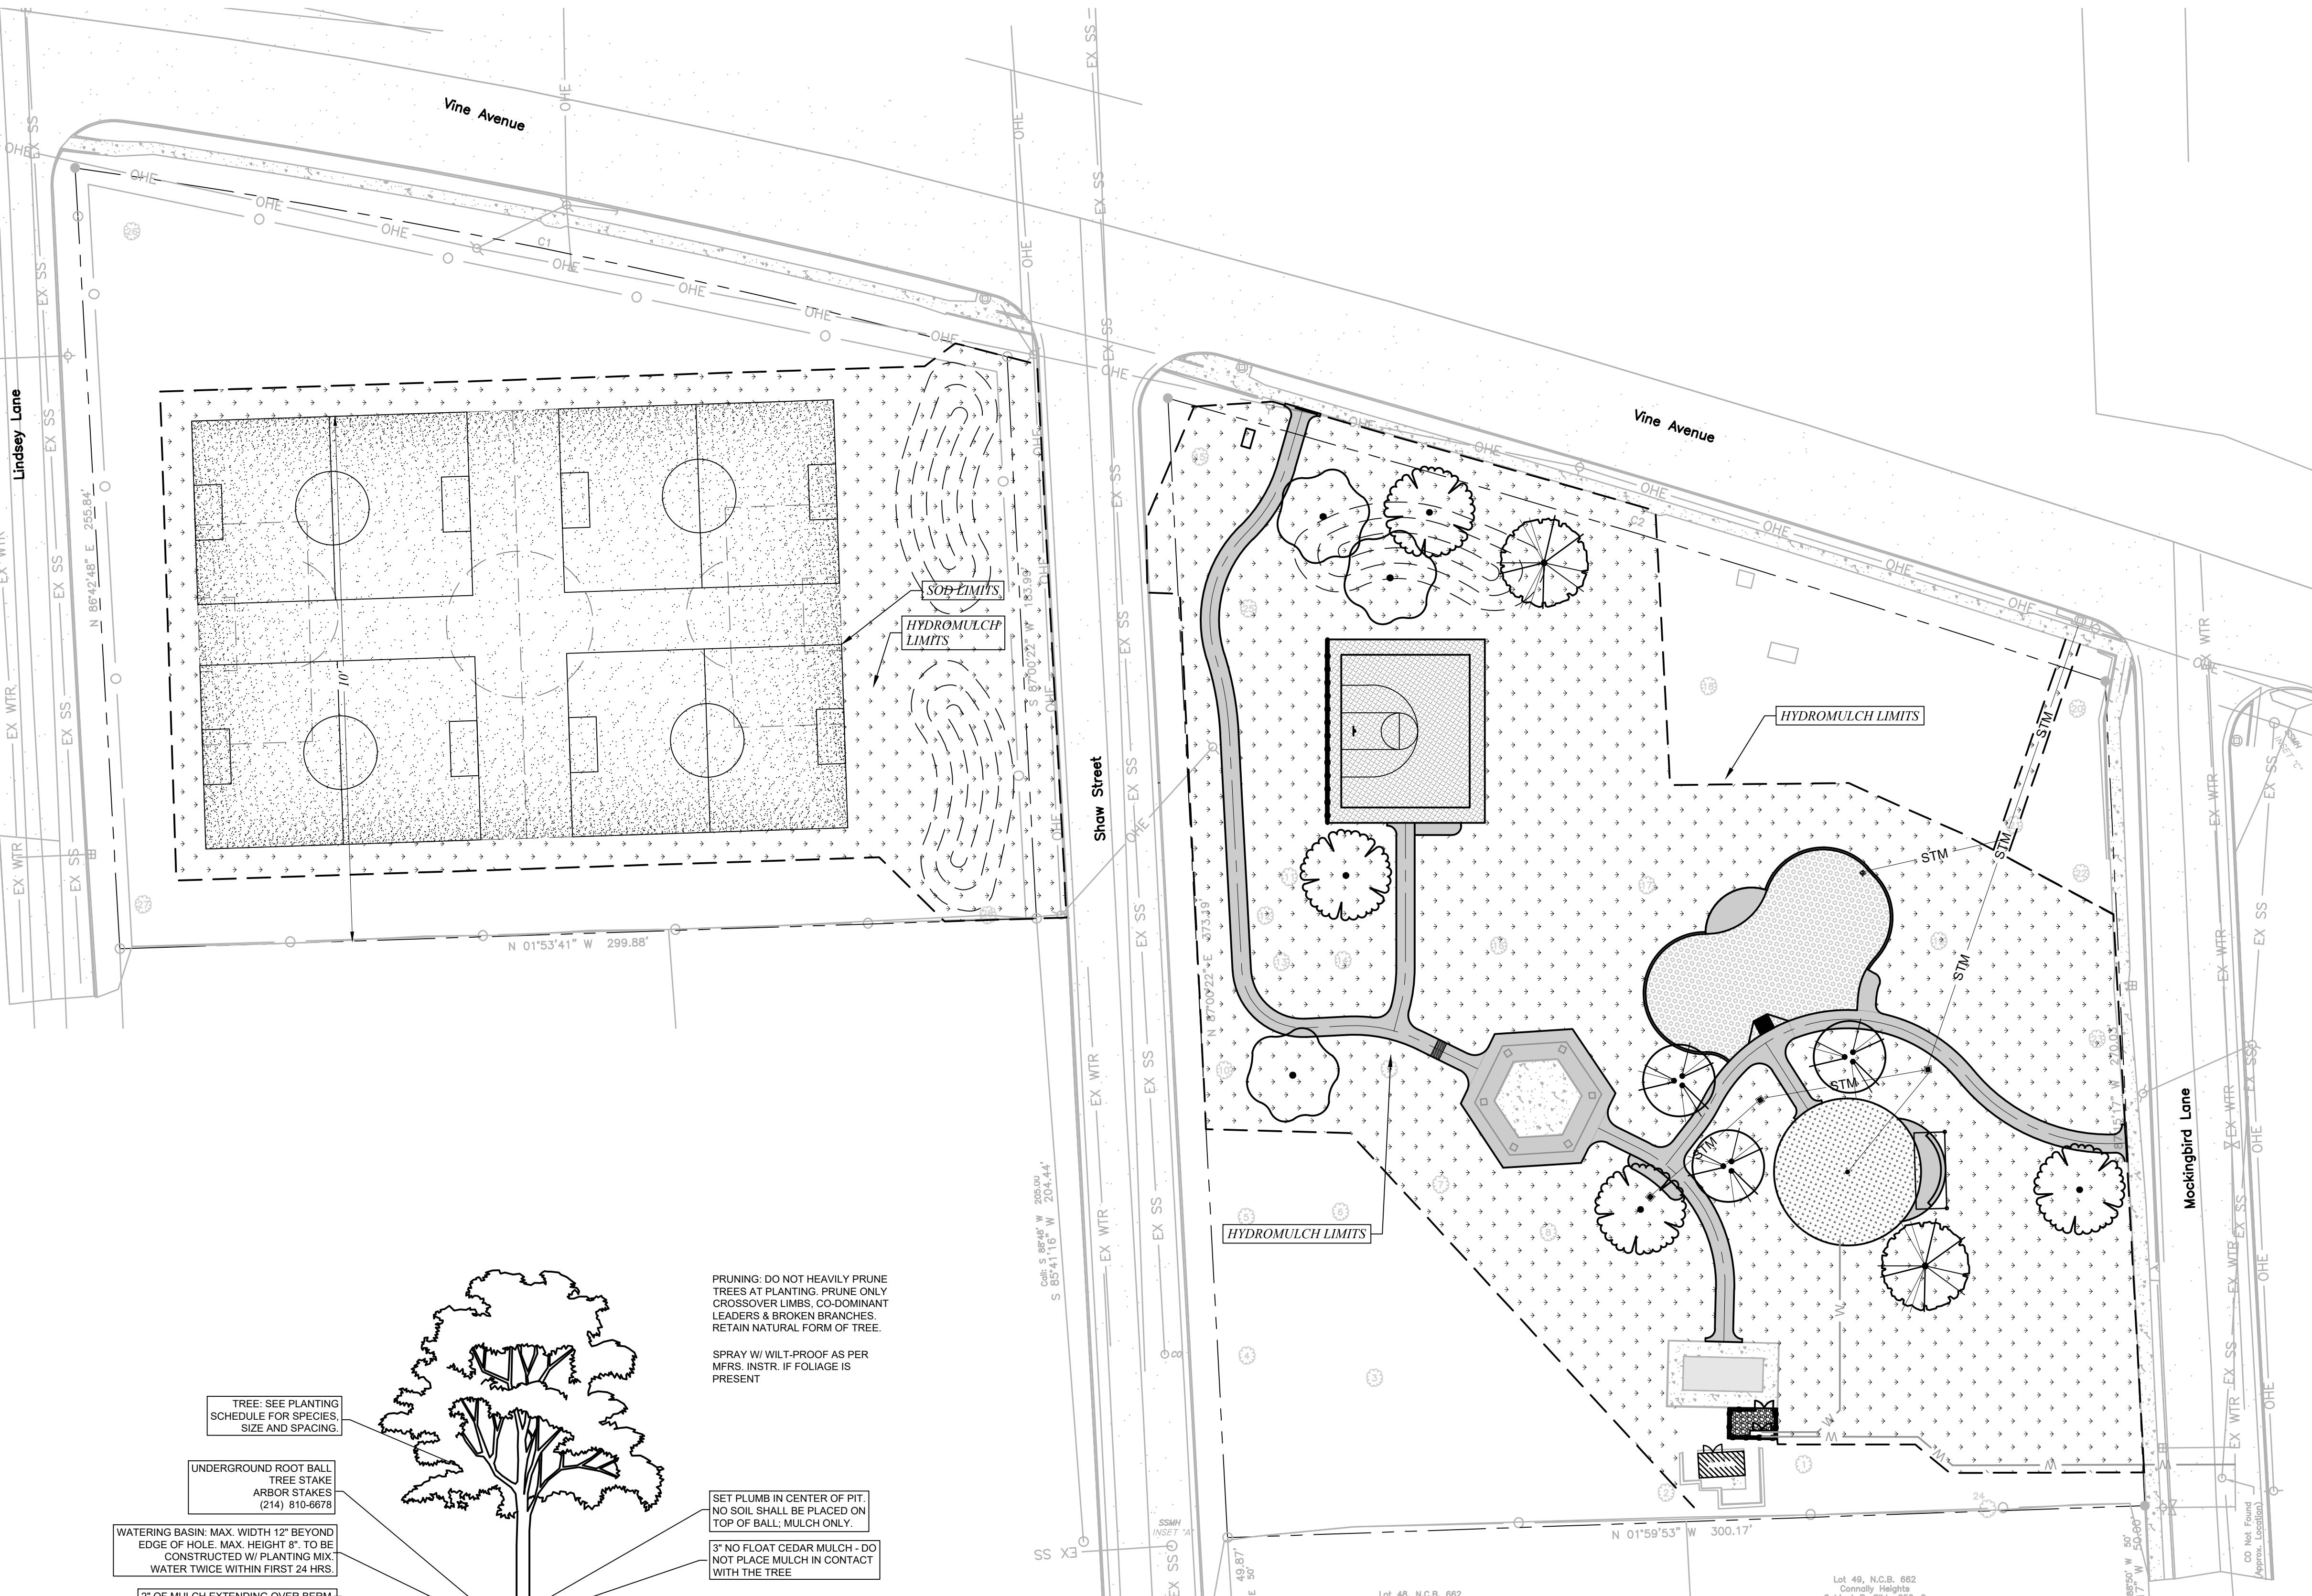
**TREE AND SOD PLAN**  
**P.T. COLE PARK**  
 CITY OF TYLER, TEXAS

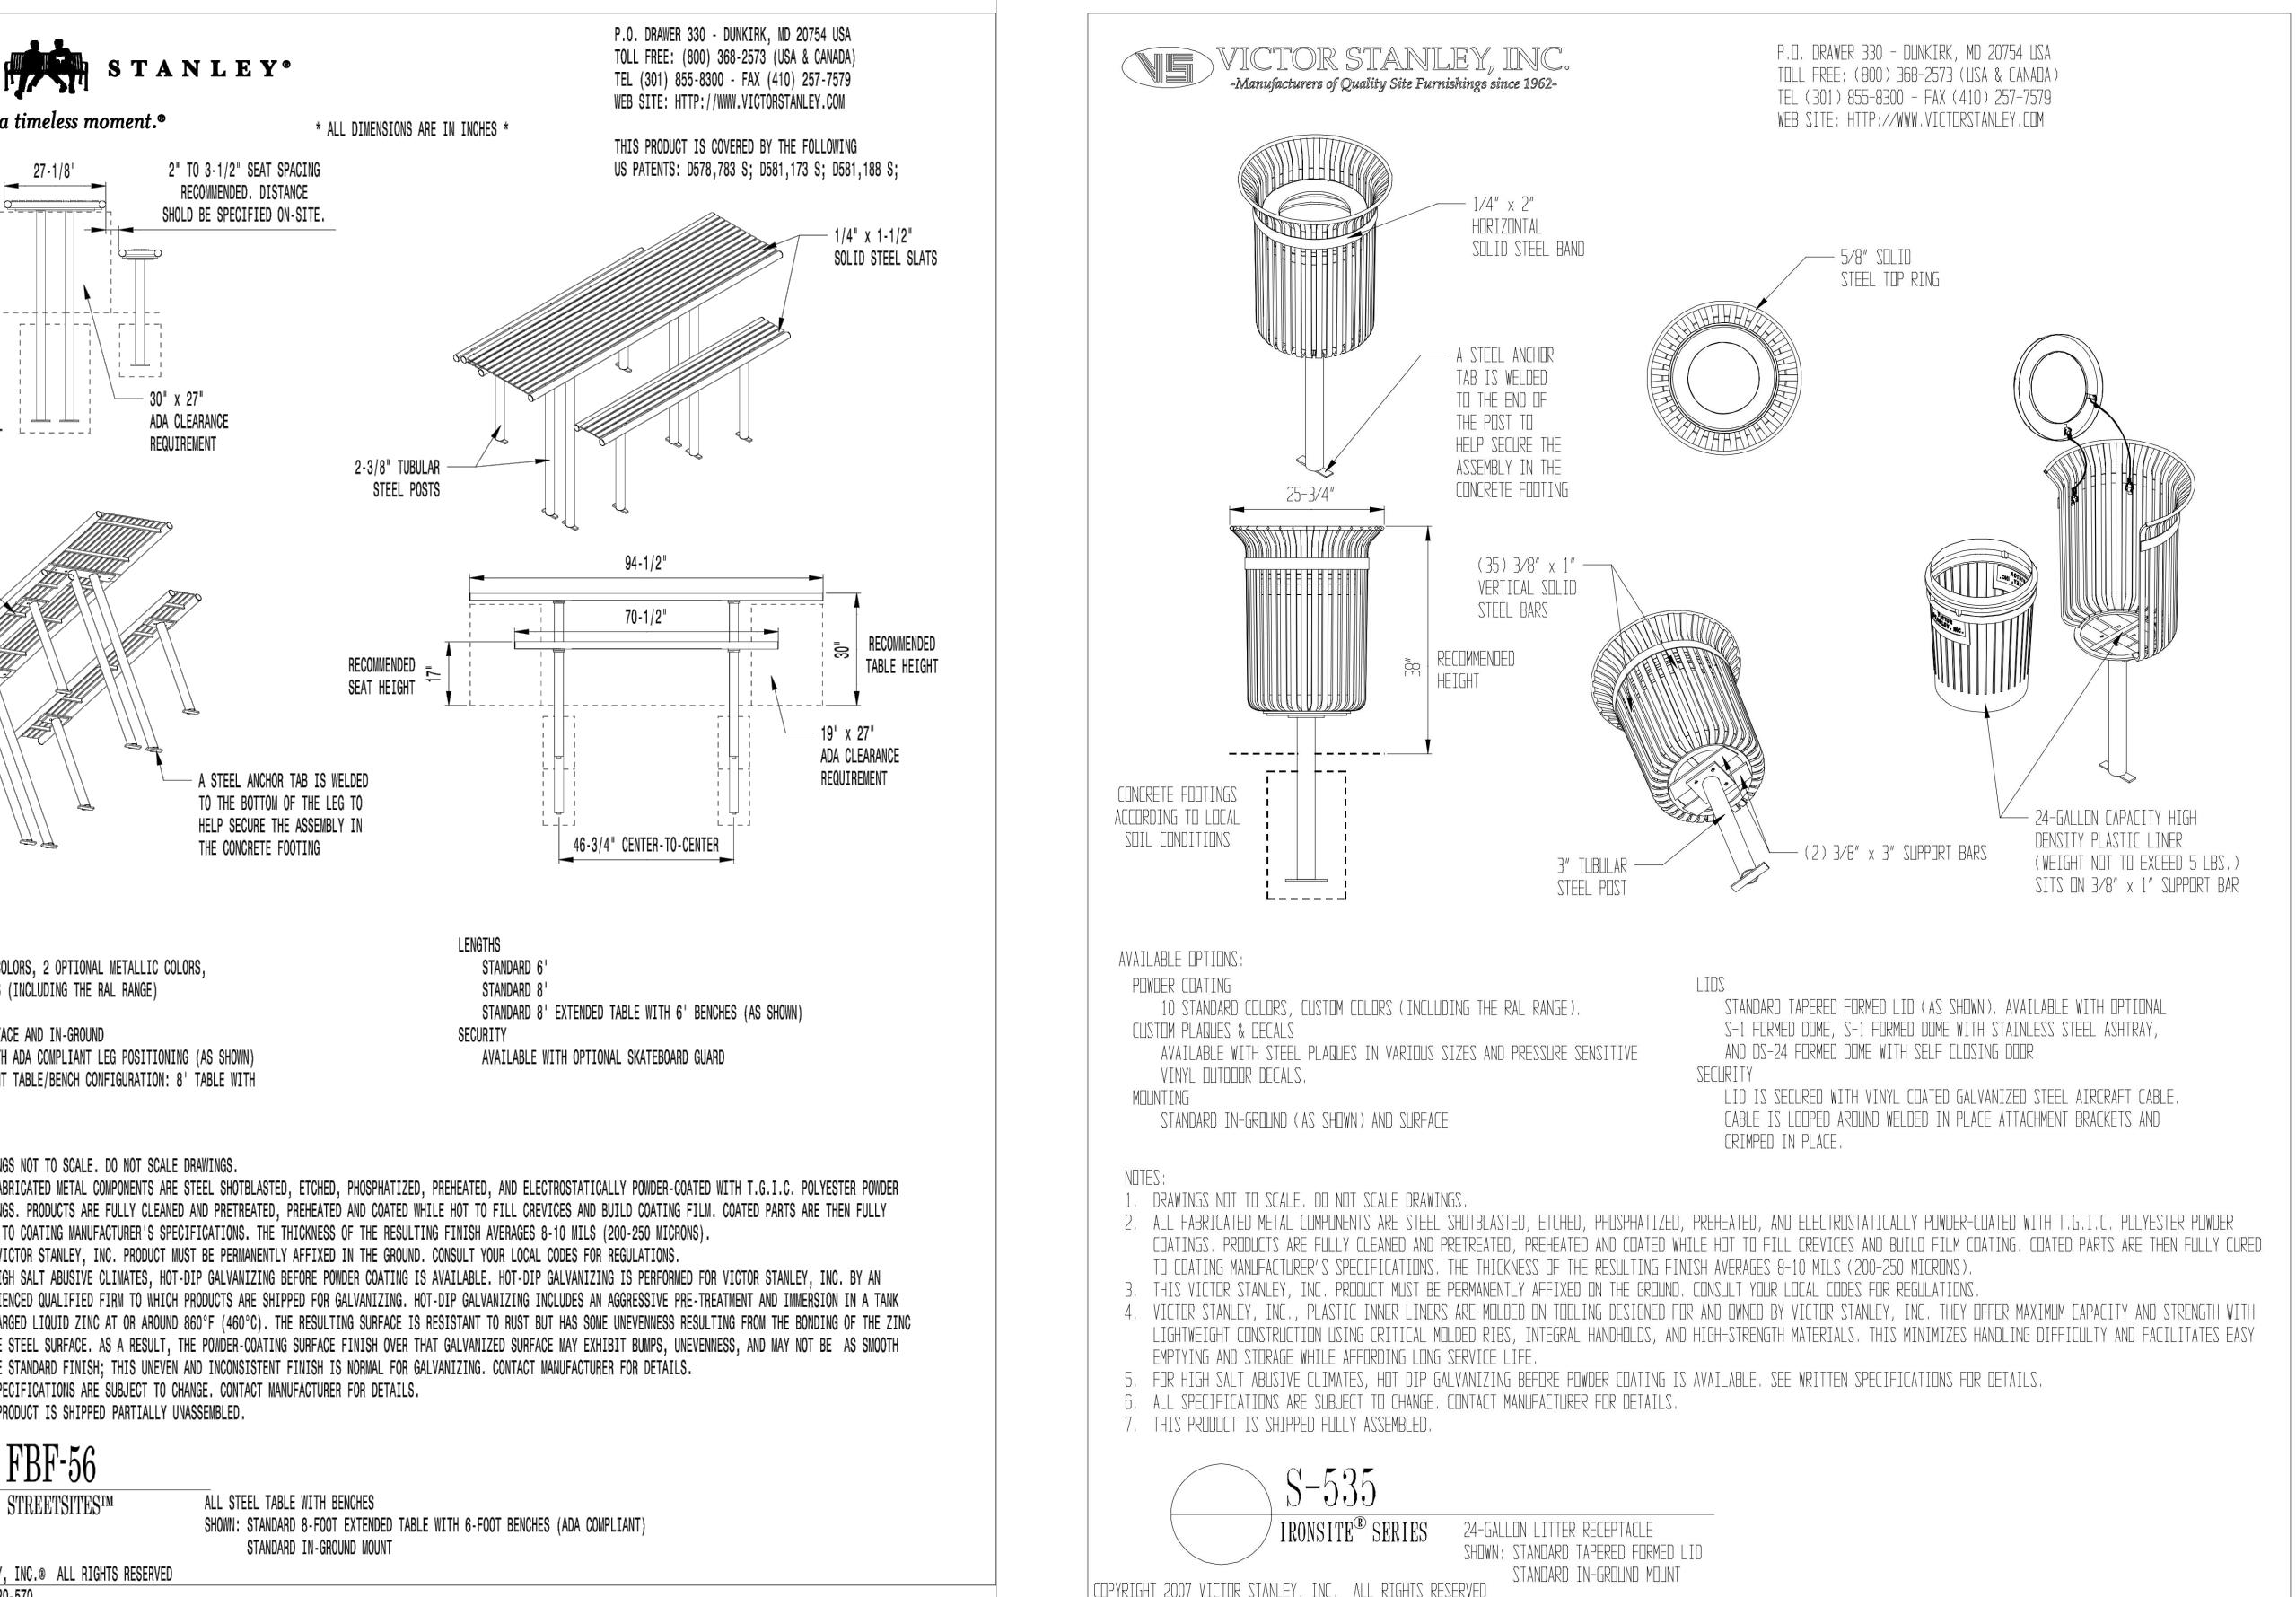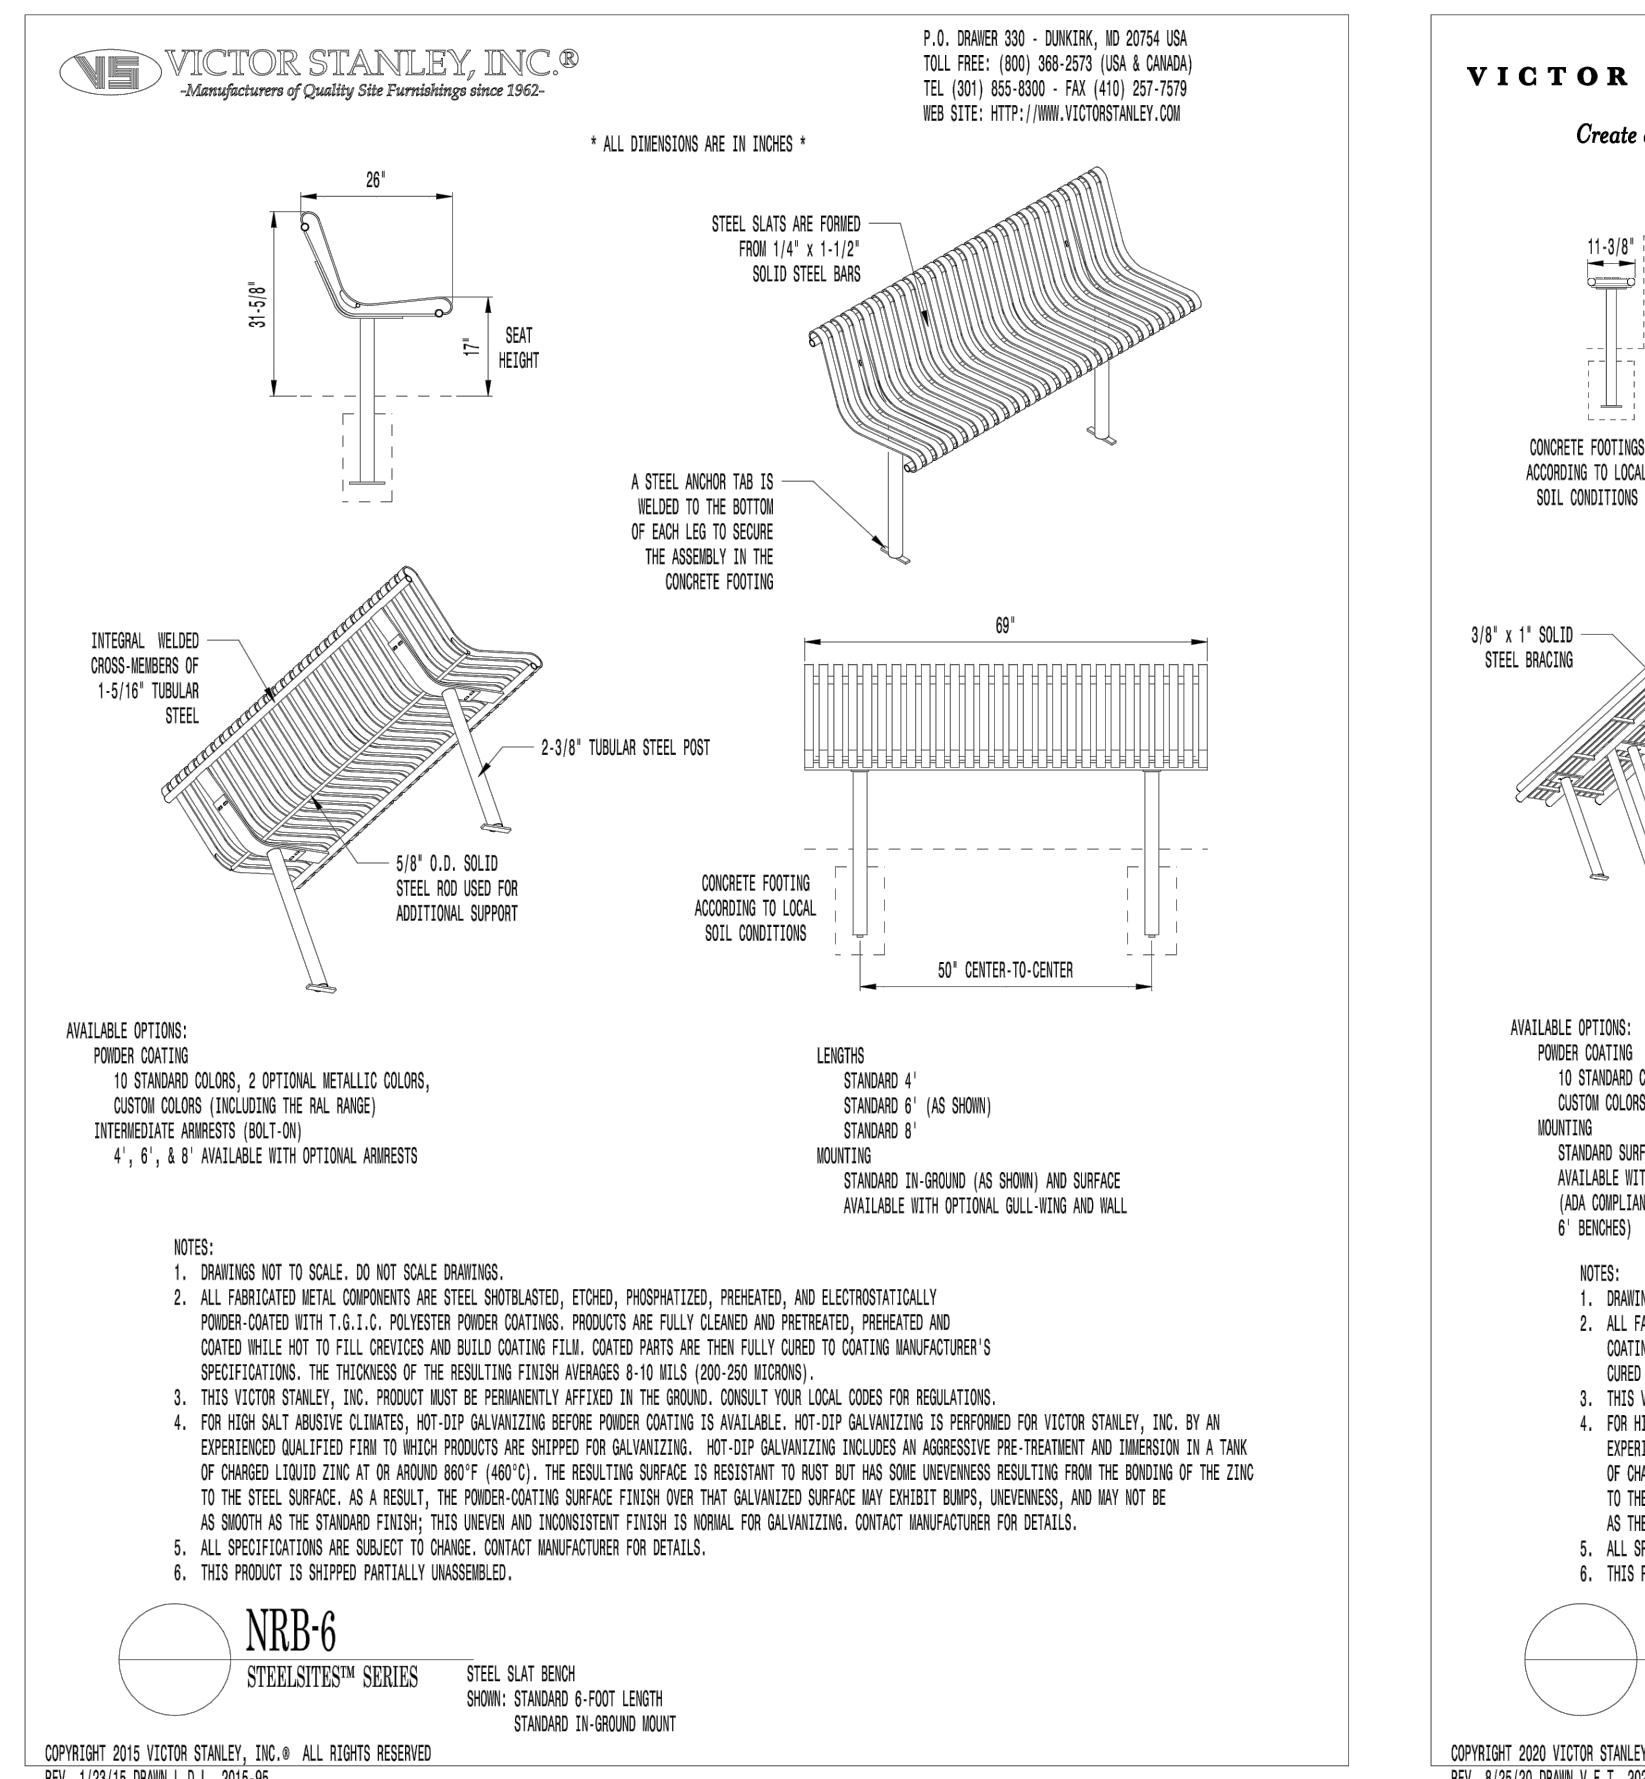


Know what's below.  
 Call before you dig.

L1

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## IRRIGATION PLAN

### P.T. COLE PARK

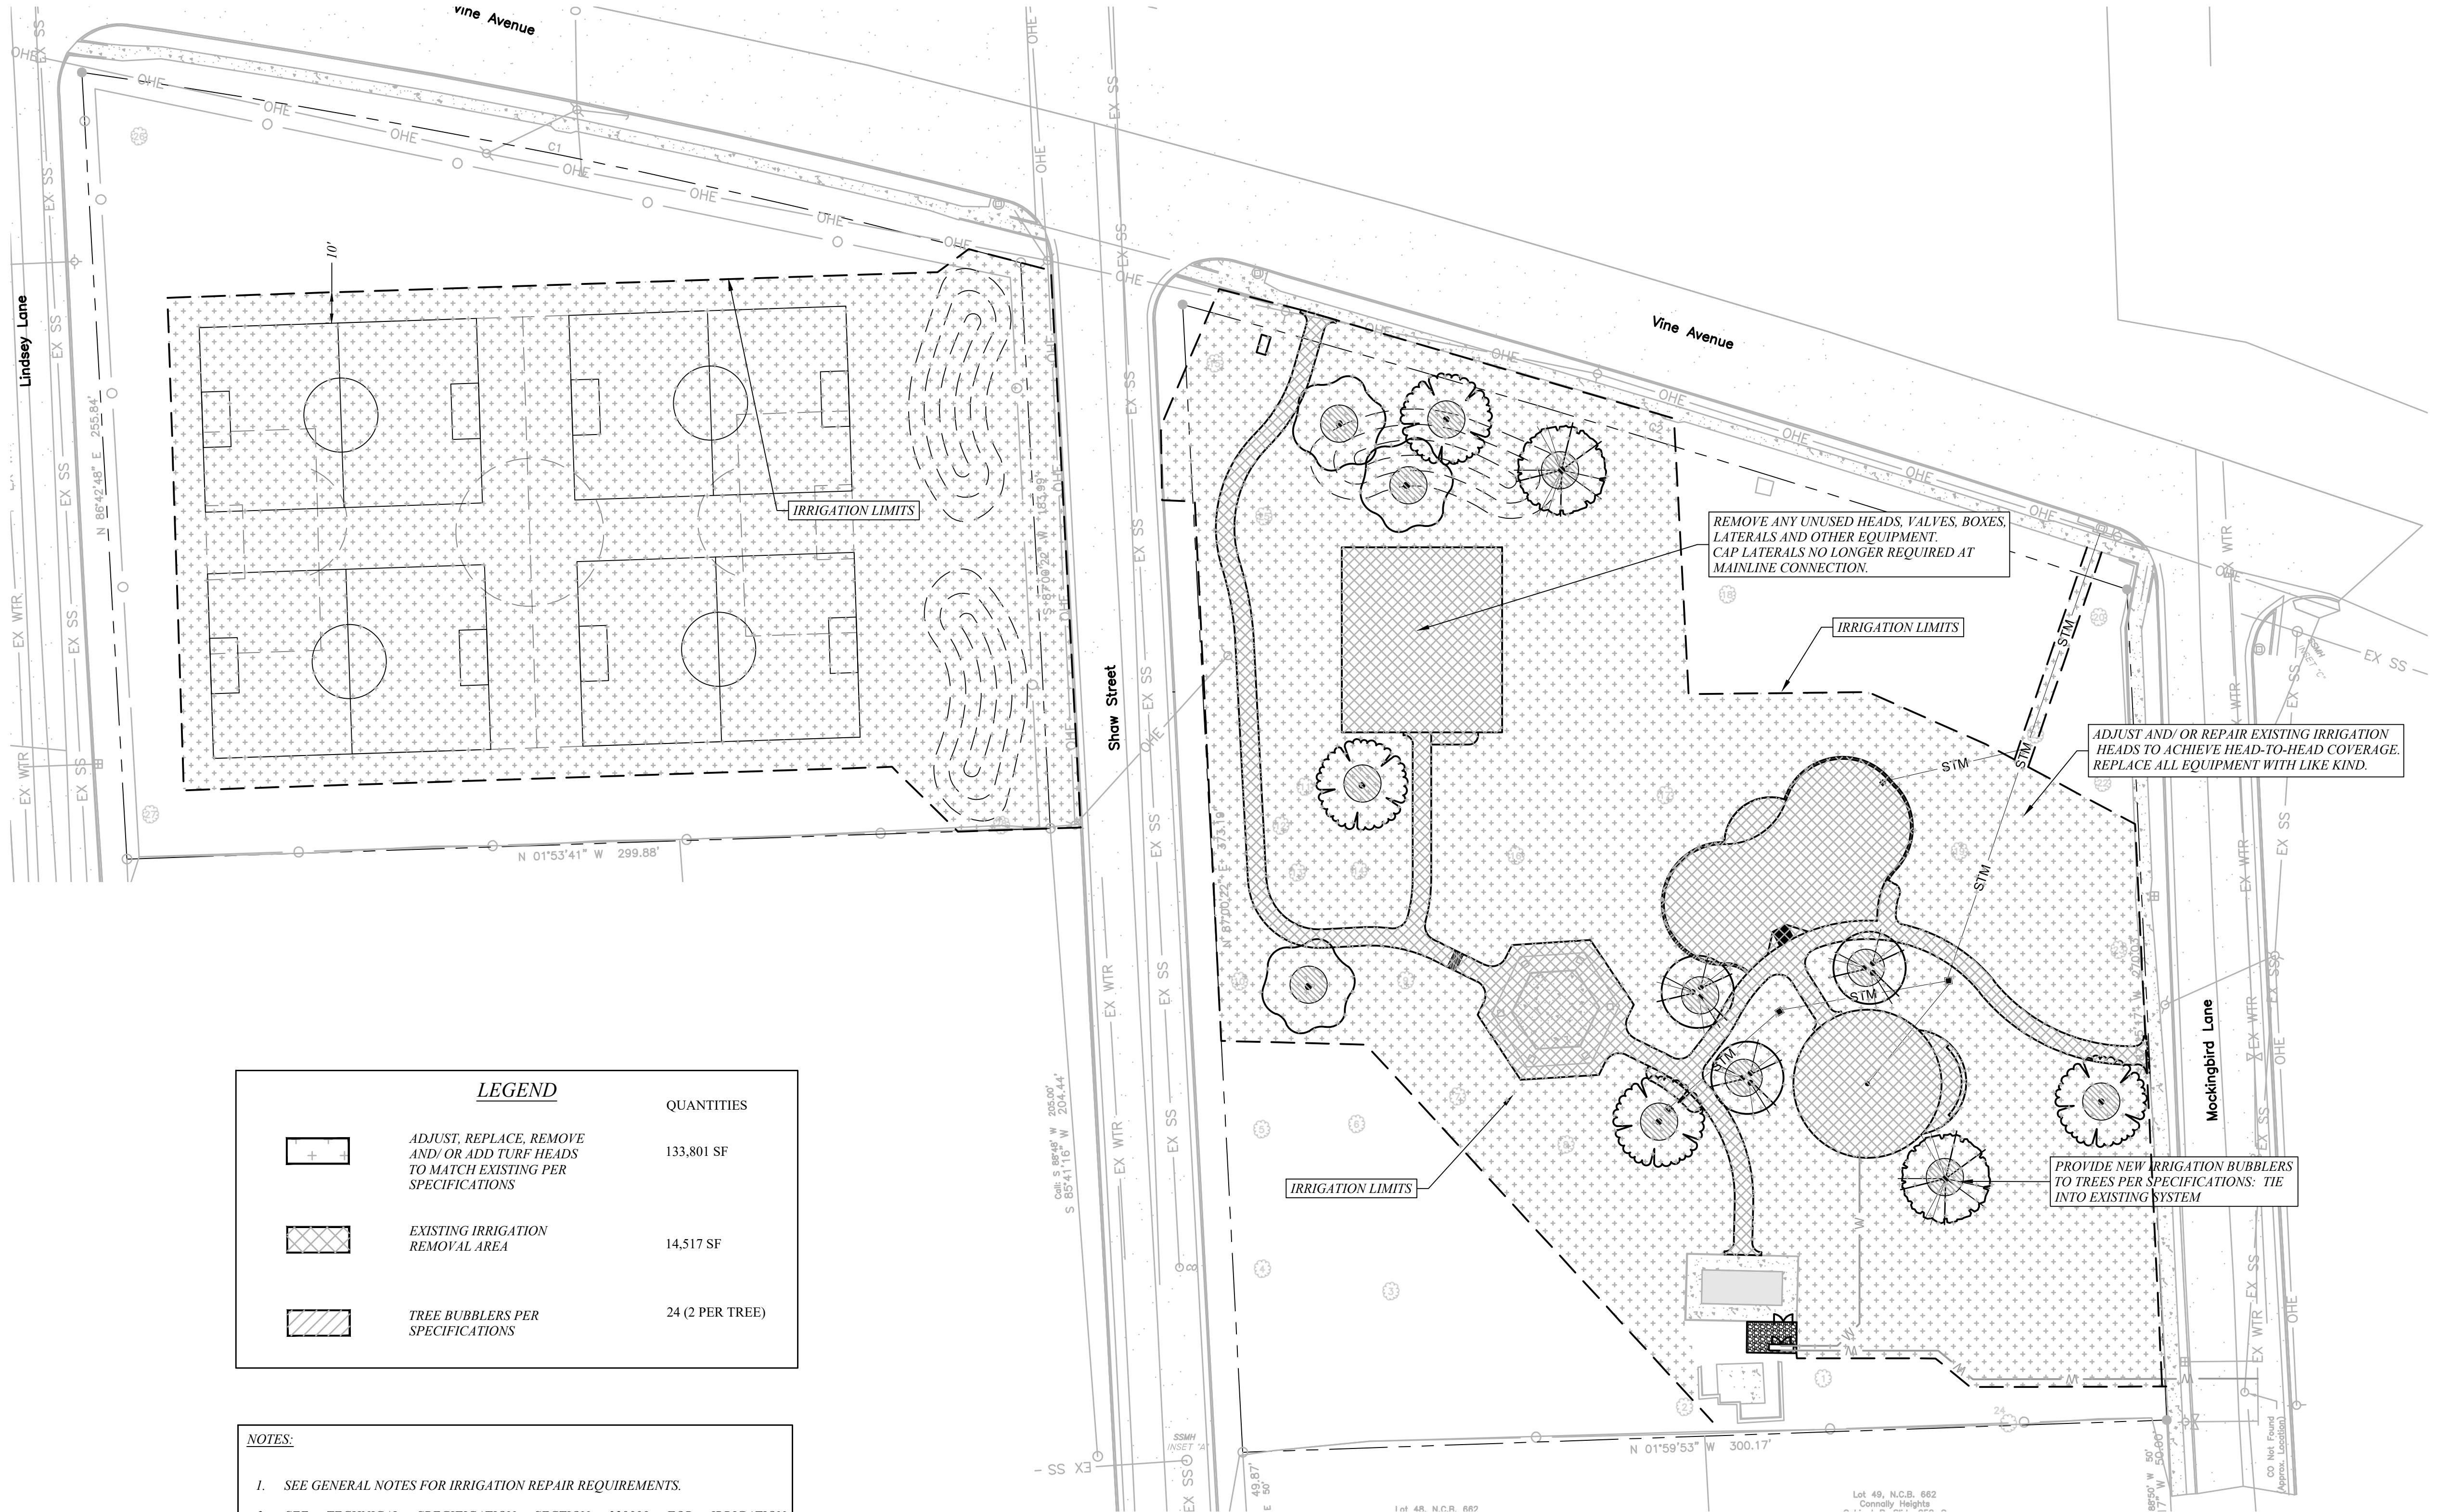CITY OF TYLER, TEXAS



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JOB NO.: 22-069

# SITE PLAN - ELECTRICAL


E-1

## SITE PLAN NOTES BY SYMBOL 'O'

- ① DISCONNECT AND REMOVE EXISTING ELECTRICAL PANEL, METER AND LIGHTING CONTROLS.
- ② DISCONNECT AND REMOVE EXISTING LIGHT, POLE AND FOUNDATION TO 24" BELOW GRADE MINIMUM.
- ③ PROVIDE AND INSTALL WR. LISTED GFCI, 20A, 125V, DUPLEX RECEPTACLE WITH METAL 'IN USE' COVER EQUAL TO TAB 'KMKMV' SERIES.
- ④ EXISTING UTILITY METER TO REMAIN. DISCONNECT AND REMOVE EXISTING LOAD CENTER AND INSTALL NEW PANEL 'L'. REFER TO RISER DIAGRAM 1/E-2 FOR ADDITIONAL INFORMATION.




DRAWN: C.A.D.  
 CHECKED: J.W.  
 DATE: Oct. 2022  
 SCALE: As Shown  
 JOB NO.: 22-069

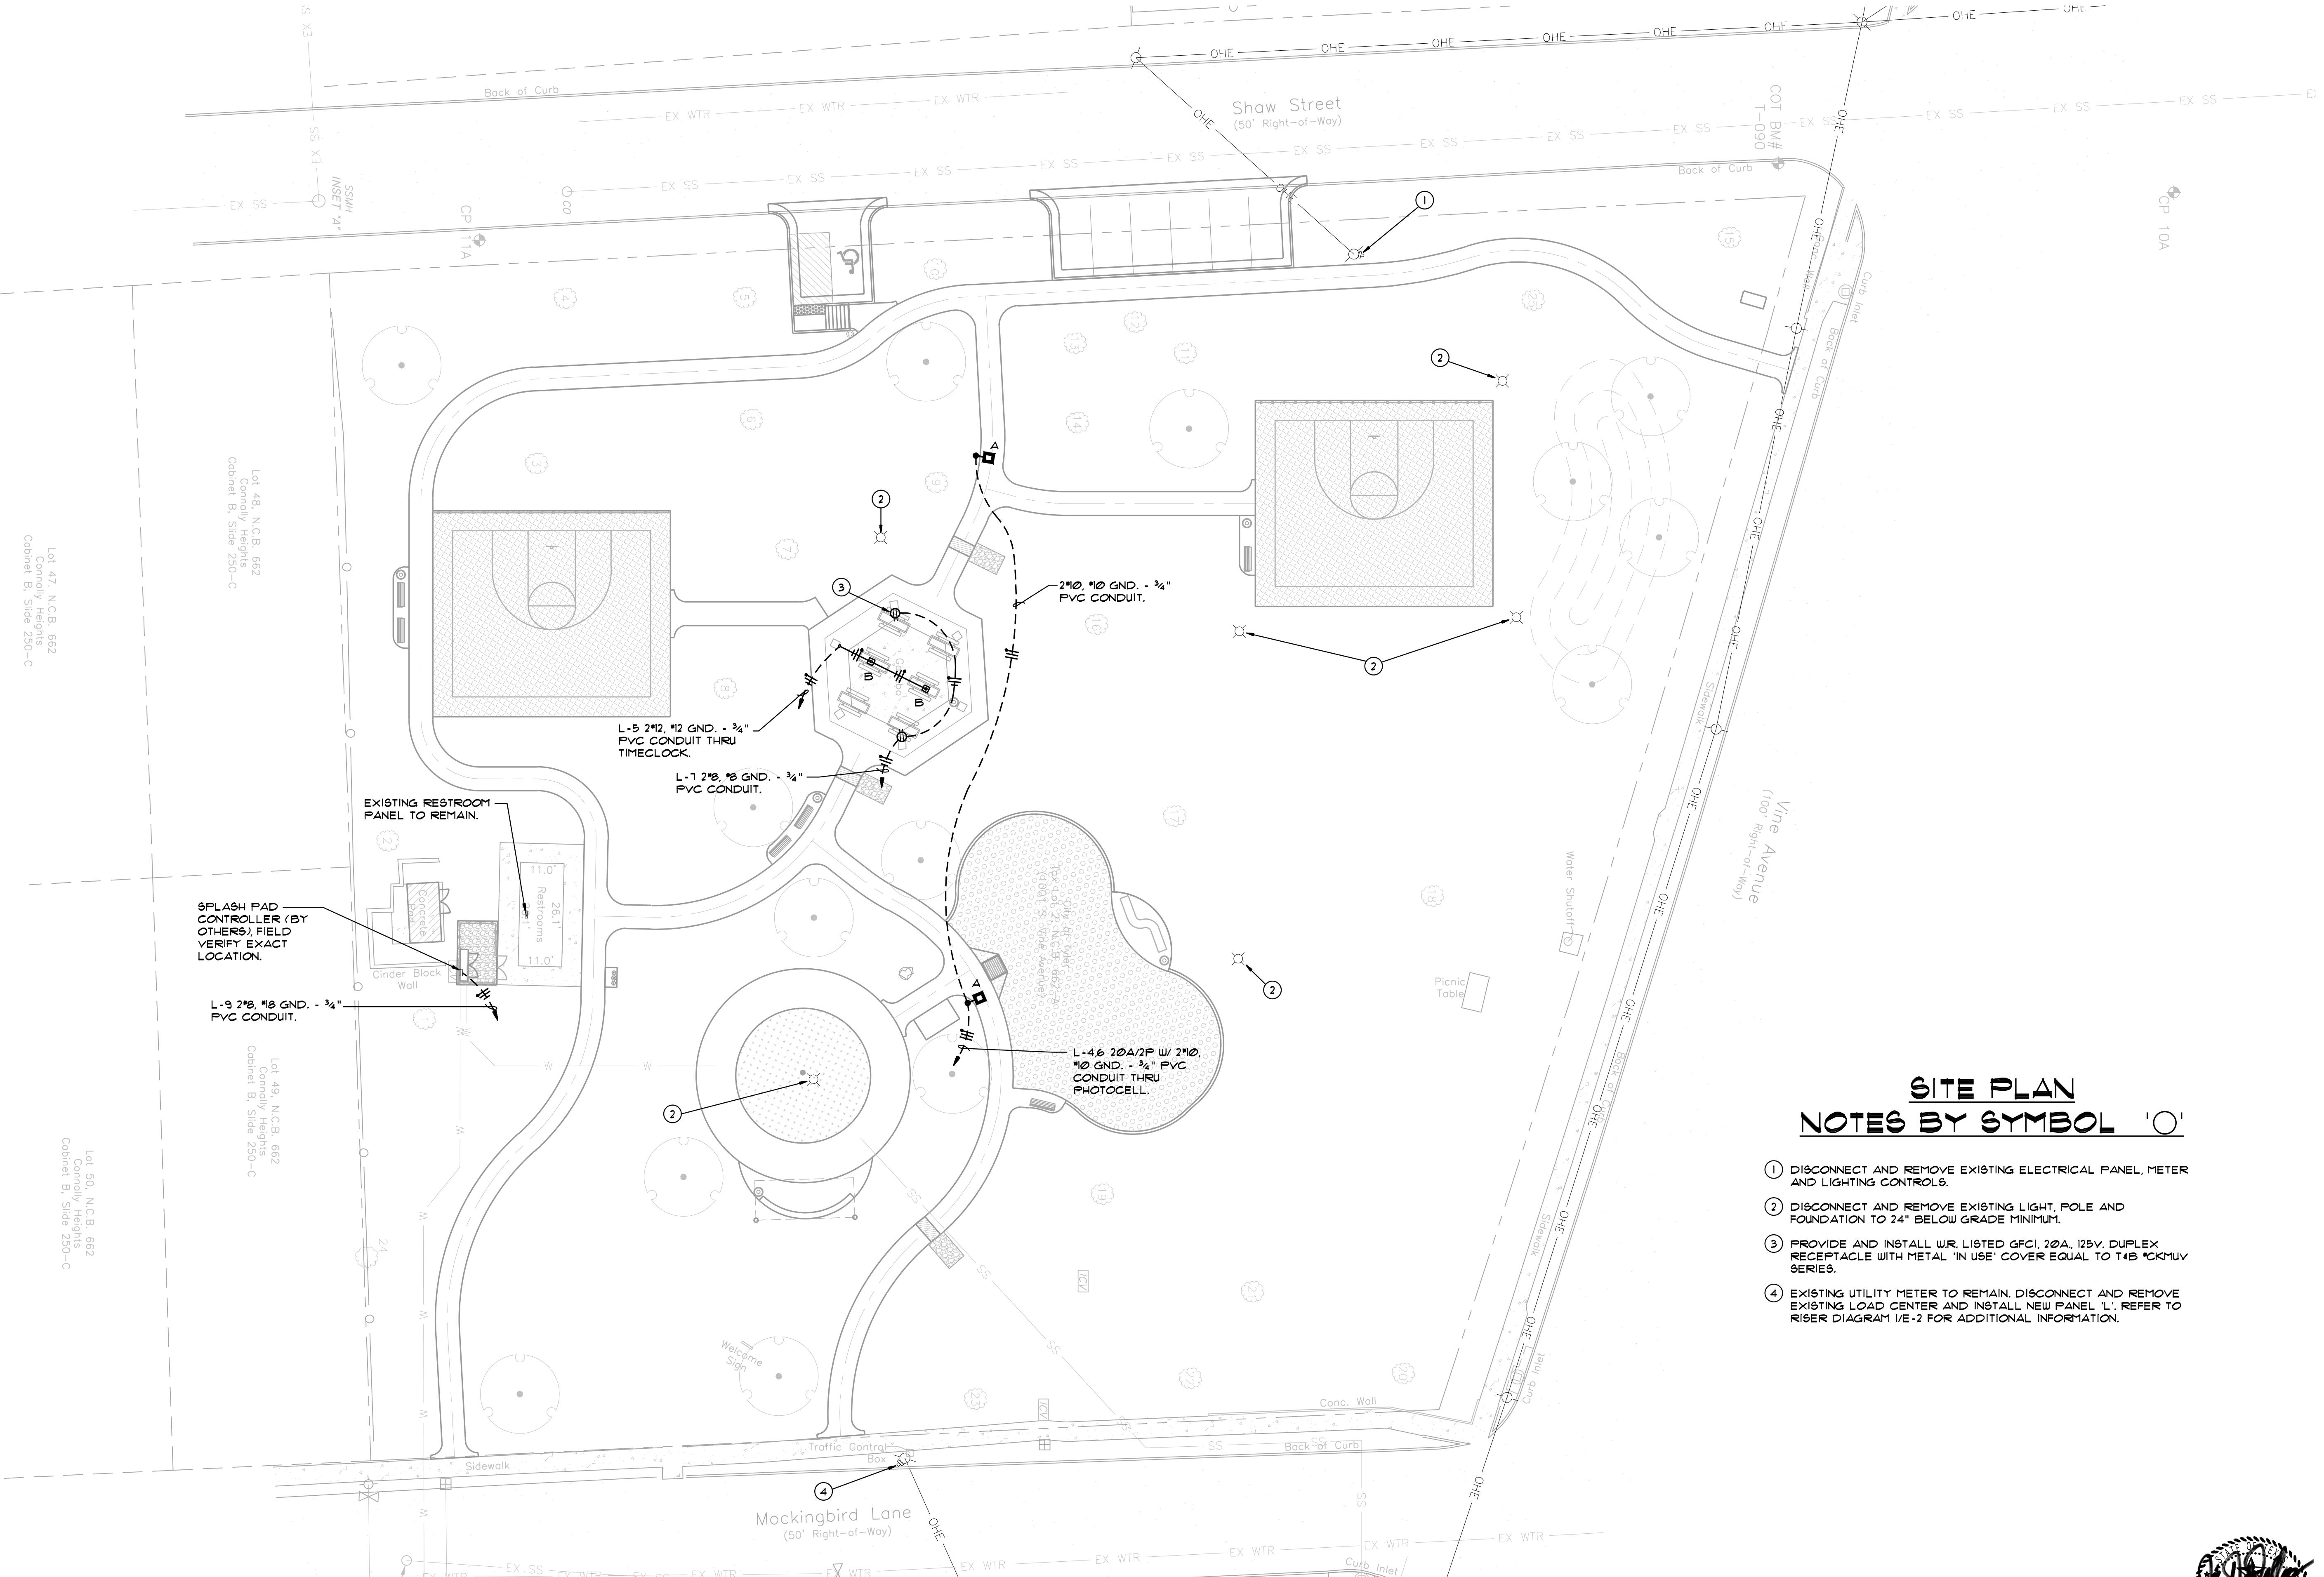




# ELECTRICAL DETAILS & SCHEDULES

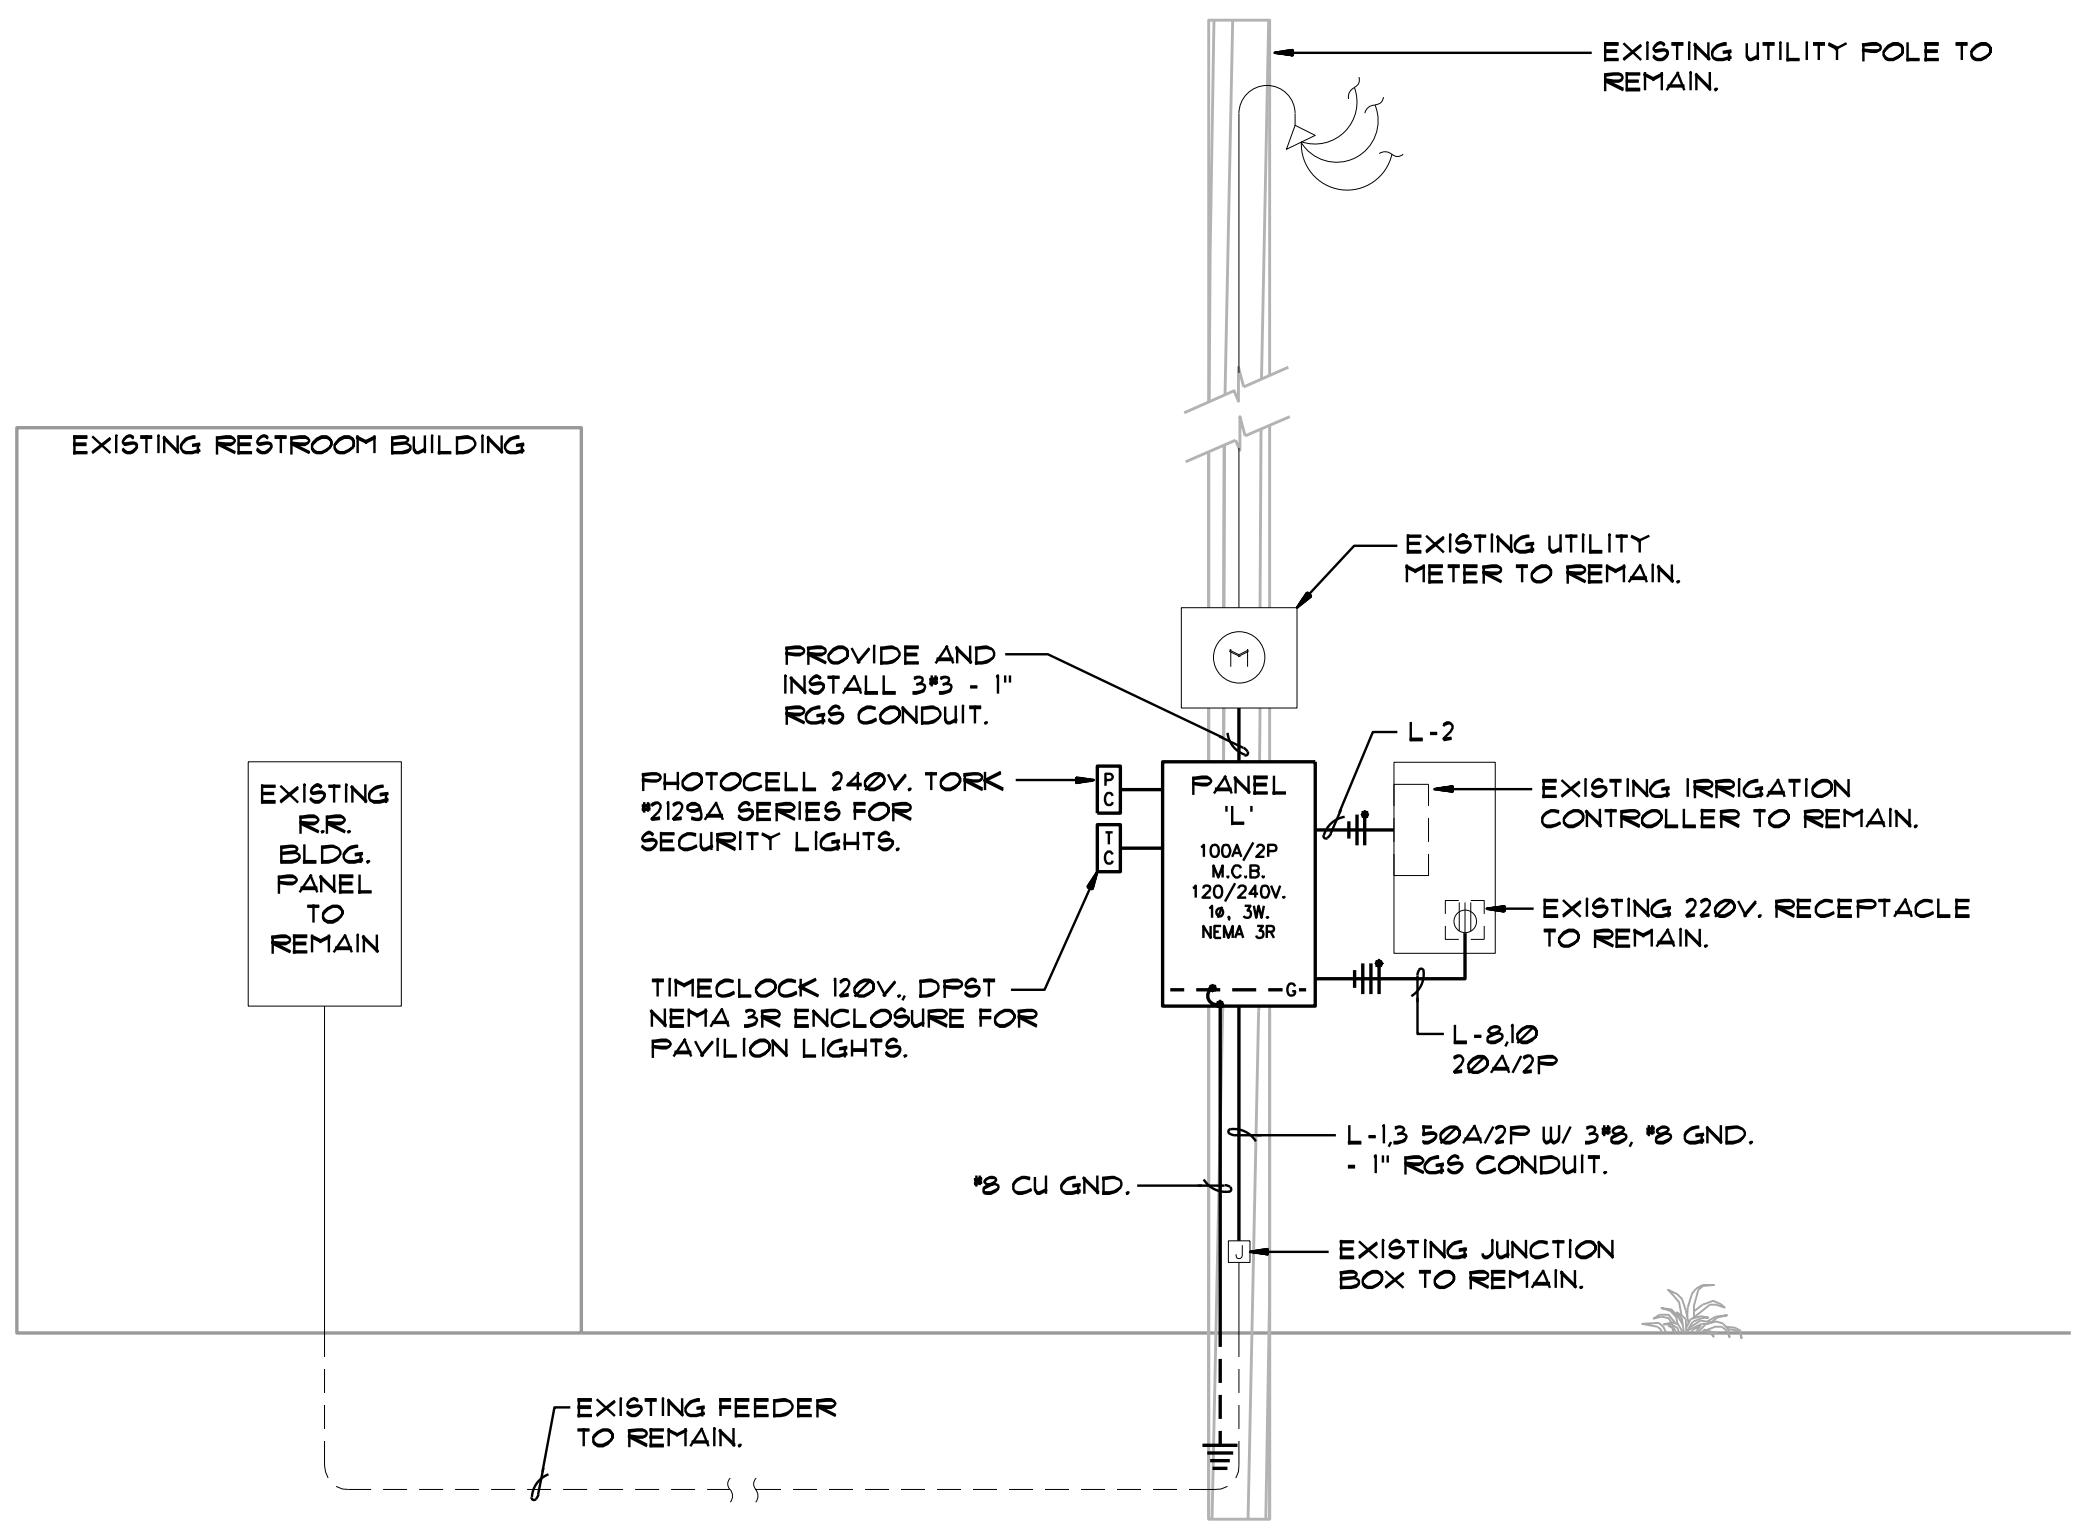

# 1 ELECTRICAL RISER DIAGRAM

SCALE: NONE

SCALE: NON

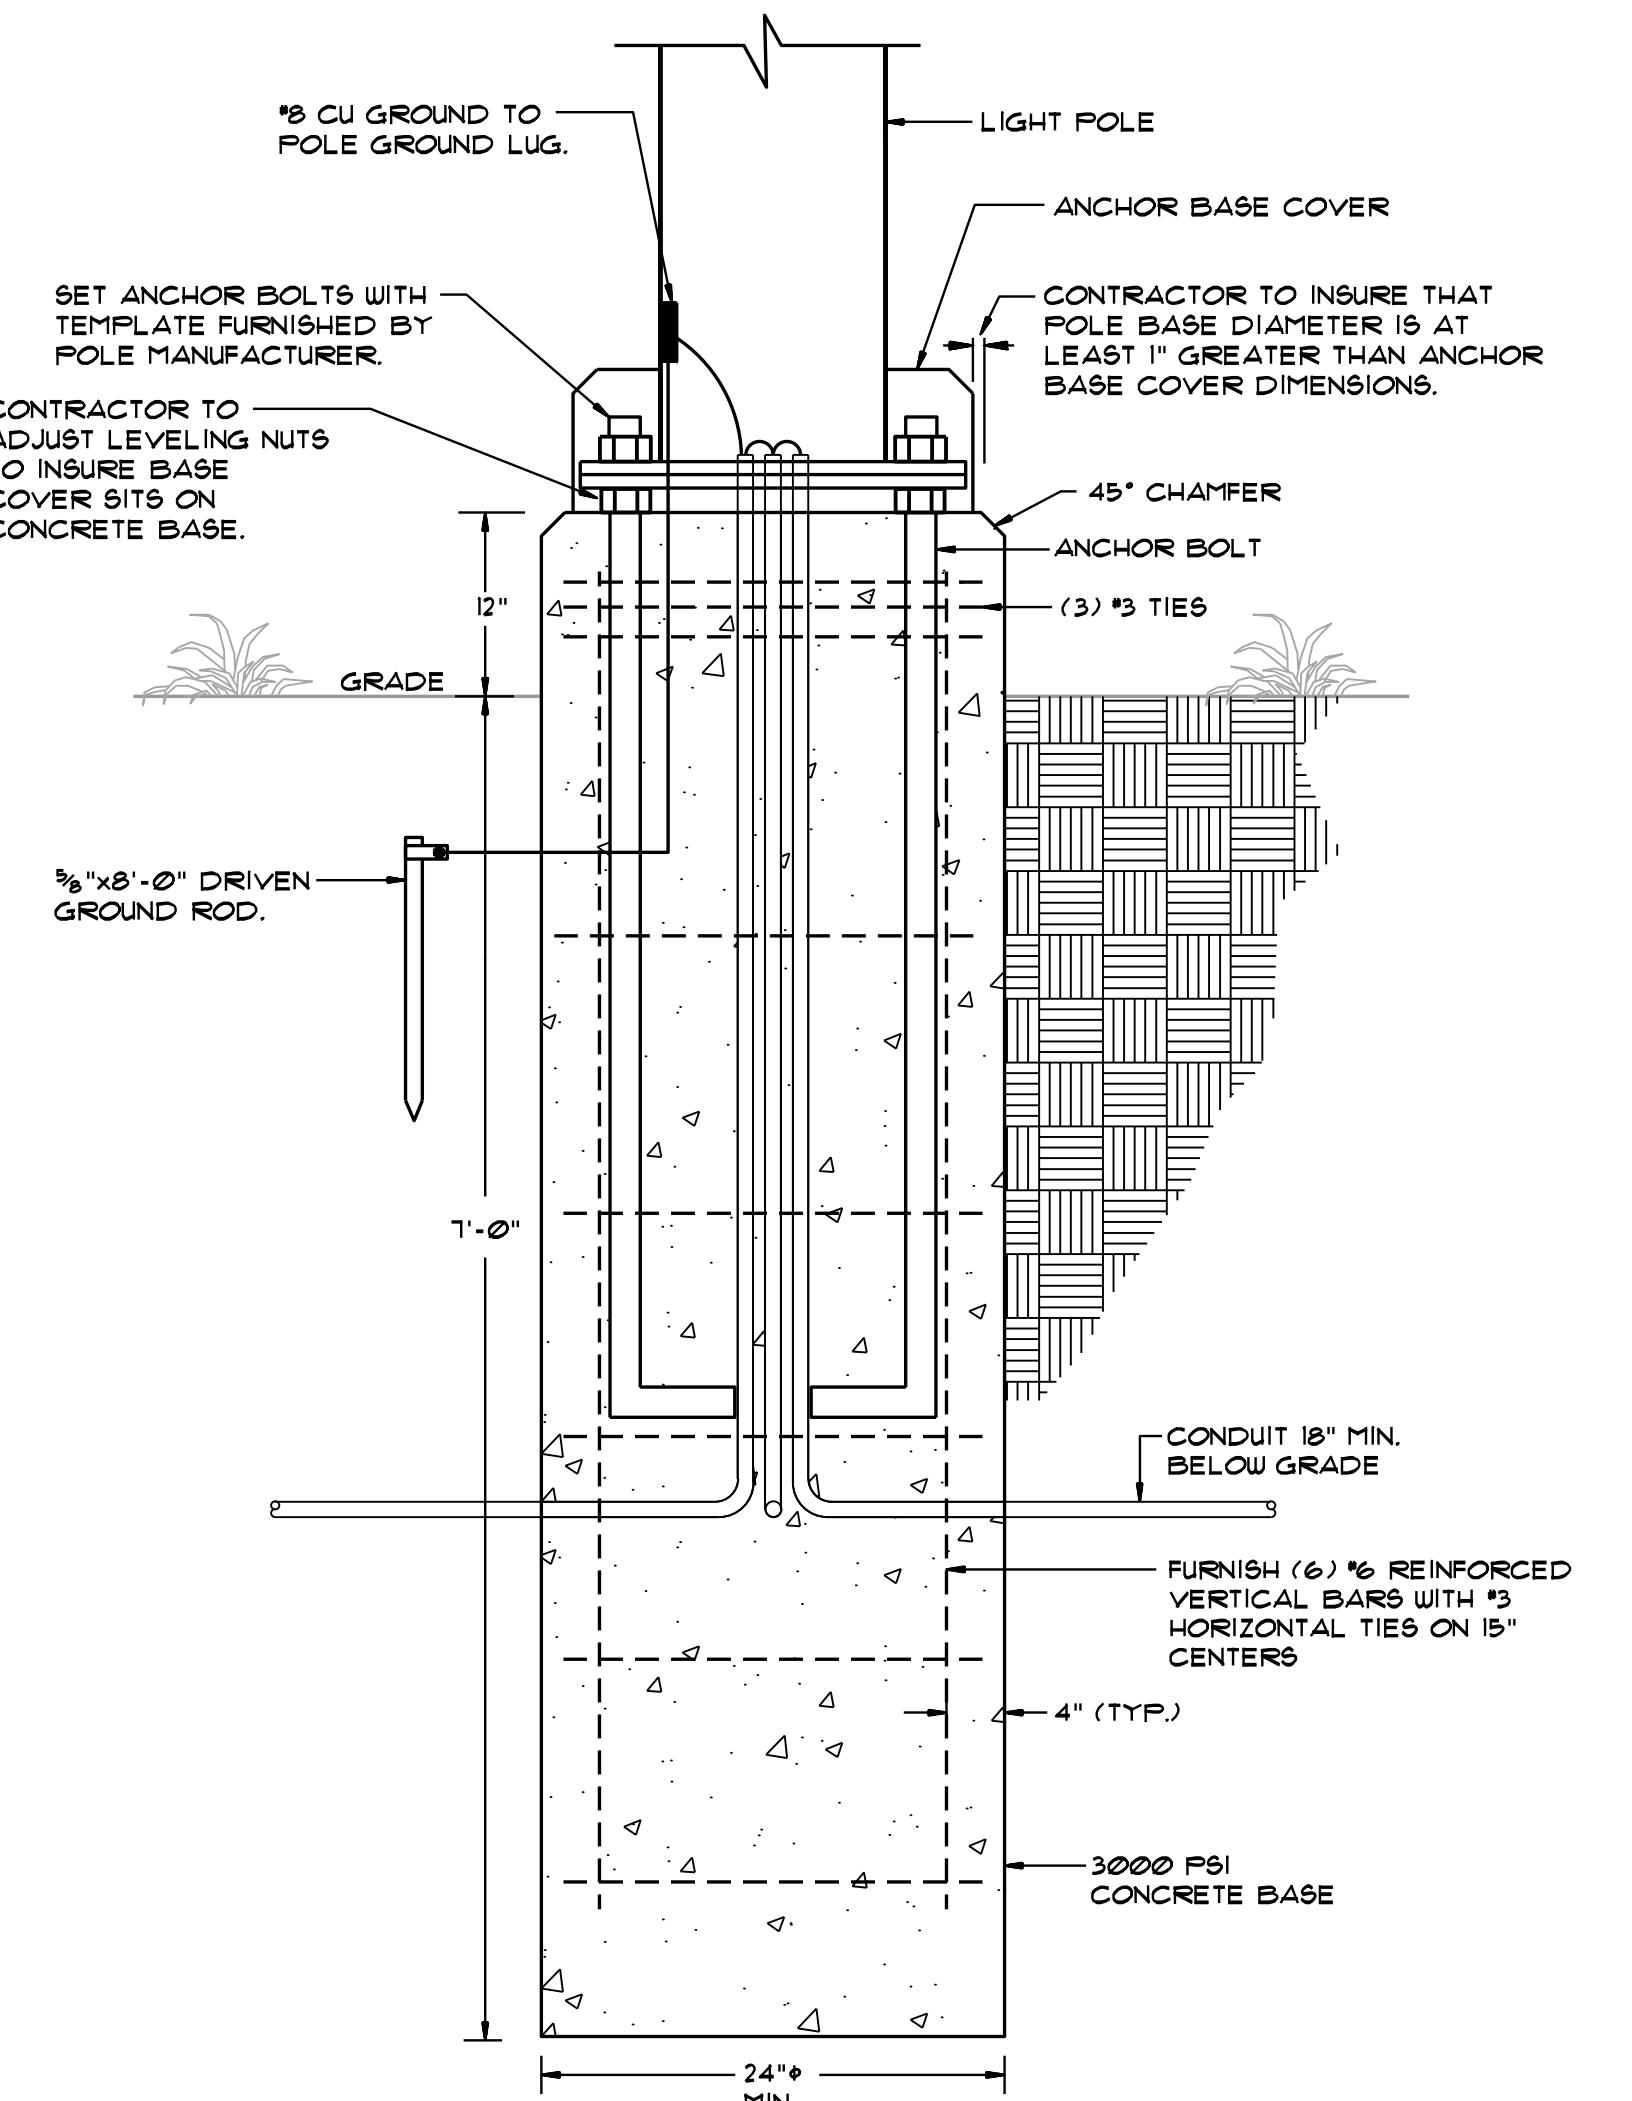

## TYPICAL POLE BASE DETAIL

SCALE: NONE

PANEL 'L'											
			LOAD		LOAD						
NOTES	DESCRIPTION	P - AMP	LIGHTING	POWER	PH / CKT #	POWER	LIGHTING	P - AMP	DESCRIPTION	NOTES	
	Existing Restroom Bldg. Panel	2 50		4800 4800	1 A 2 3 B 4	600 89		1 - 20 2	Exist. Irrigation Controller Security Lights		
	Pavilion Lights	1 - 20	54		5 A 6		89	20		1	
	Pavilion Receptacles	1 - 20		1200	7 B 8	1800		20	Existing 220V. Receptacle		
	Splash Pad Controller	1 - 20		1500	9 A 10	1800					
	Space Only	1 - -	-----	-----	11 B 12	-----	-----	1 - -	Space Only		
	Space Only	1 - -	-----	-----	13 A 14	-----	-----	1 - -	Space Only		
	Space Only	1 - -	-----	-----	15 B 16	-----	-----	1 - -	Space Only		
	Space Only	1 - -	-----	-----	17 A 18	-----	-----	1 - -	Space Only		
LOAD SUMMARY				CONN. KW	N.E.C. DIV.	DIV. KW					
LIGHTING				0.2	X 1.25	0.3	POLES 18				
POWER				16.5	X 1.0	16.5	SIZE 100 AMP				
OTHER				0.0	X 1.0	0.0	MAINS 100A/2P M.C.B.				
							VOLTS 120/240V., 1Ø, 3W				
							A.I.C. 10K				
							MOUNTING Surface				
							ENCLOSURE Lockable NEMA 3R				
TOTALS				16.7		16.8					
PROJECT PT Cole Park Tyler, Texas				NOTES: 1. Route circuit thru photocell.				PANEL AMPS 70			
PANEL LOCATION: Existing Utility Pole								LOADS PER PHASE:			
DATE: October 2022								PHASE A (KW) 8.8			
								PHASE B (KW) 7.9			

# LUMINATOR SCHEDULE

Type	Description	Manufacturer/Model #	Voltage	Wattage	Lamps	Remarks
A	POLE MOUNTED LED AREA LUMINAIRE ON 25'-0" SQUARE STRAIGHT STEEL POLE	LITHONIA "DSXO LED P5 40K T5W MVOLT SPA DBLXD POLE: AMERICAN LITE POLE #SNS-25-40-II-AB-BLK	120/277	89	LEDS FURNISHED	REFER 2/E-2 FOR POLE BASE DETAIL
B	SURFACE MOUNTED VANDAL RESISTANT LED LUMINAIRE	DURA GUARD "VN 34 Q F 1X23 U 4K LP BLK	120/277	27	LEDS FURNISHED	



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CHECKED: J.W  
DATE: Oct. 2022  
SCALE: As Shown  
JOB NO.: 22-069

## ELECTRICAL SPECIFICATIONS

## DIVISION 16

## ELECTRICAL SPECIFICATIONS:

## A. GENERAL:

1. PROVIDE MATERIALS, LABOR, TOOLS, TRANSPORTATION, ETC. FOR COMPLETE OPERATING ELECTRICAL SYSTEMS FOR LIGHTING, POWER AND CONTROL AS DESCRIBED HEREIN AND ILLUSTRATED ON THE DRAWINGS.
2. EXISTING EQUIPMENT, OUTLETS, AND/OR LIGHTING FIXTURES WHICH ARE TO BE REMOVED SHALL BE DISCONNECTED FROM THEIR SOURCE OF SUPPLY. BRANCH CIRCUIT FEEDER AND CONTROL WIRING SHALL BE REMOVED BACK TO THE SOURCE OF SUPPLY AND CONDUIT OR RACEWAY SHALL BE REMOVED BACK TO A POINT WHICH WILL NOT BE EXPOSED TO VIEW FROM FINISHED SPACES.
3. EXISTING OUTLETS WHICH ARE TO REMAIN ACTIVE AND HAVE HAD THEIR CIRCUIT INTERRUPTED DUE TO REMOVAL OR DEMOLITION SHALL BE RECONNECTED TO THE SOURCE OF SUPPLY WITH EQUAL CAPACITY CONDUCTORS IN METAL CONDUIT IN EXPOSED AREAS, AND PVC CONDUIT IN UNDERGROUND INSTALLATIONS.
4. FIXTURES AND EQUIPMENT WHICH ARE INDICATED TO BE REMOVED OR WHICH ARE NOT REQUIRED FOR REUSE SHALL HAVE WIRING REMOVED BACK TO THE SOURCE OF SUPPLY.

## B. SCOPE OF WORK:

1. WORK INCLUDED: PROVIDE COMPLETE ELECTRICAL WORK WHERE SHOWN ON DRAWINGS, AS SPECIFIED HEREIN, AND AS NEEDED FOR A COMPLETE AND PROPER INSTALLATION INCLUDING, BUT NOT NECESSARILY LIMITED TO THE FOLLOWING SUMMARY OF WORK:
  - a. PANELBOARD.
  - b. PAVILION LIGHTING FIXTURES.
  - c. POLE MOUNTED SITE AND AREA LIGHTING FIXTURES.
  - d. SERVICE ENTRANCE GROUNDING SYSTEM.
  - e. LIGHTING CONTROLS, PHOTOCELLS AND TIMECLOCKS.
  - f. WIRING DEVICES AND BRANCH CIRCUIT WIRING.
  - g. OTHER ITEMS AND SERVICES REQUIRED TO COMPLETE THE SYSTEMS.

## C. CODE COMPLIANCE:

1. ELECTRICAL WORK TO CONFORM WITH THE 2011 EDITION OF THE NATIONAL ELECTRICAL CODE (NEC) AND APPLICABLE LOCAL ORDINANCES.

## D. RACEWAYS:

1. RACEWAYS SHALL BE SIZED AS INDICATED ON THE DRAWINGS AND AS REQUIRED BY THE NEC. TO PREVENT DAMAGE TO THE CONDUCTORS DO NOT USE RACEWAYS SIZED LESS THAN 3/4" UNLESS SPECIFIED OTHERWISE.
2. PROVIDE GALVANIZED RIGID METAL RACEWAY FOR ALL USES IN DAMP AND WET LOCATIONS, IN HAZARDOUS AREAS AND IN LOCATIONS SUBJECT TO PHYSICAL DAMAGE.
3. ALL CONDUIT ENTERING BOXES SHALL BE SECURED WITH INSULATING THROAT CONNECTORS AND LOCKNUTS.
4. PROVIDE LIQUIDTIGHT FLEXIBLE CONDUIT CONNECTION FOR FINAL CONNECTION TO EACH MOTOR, NOT TO EXCEED 36 INCHES IN LENGTH.
5. ALL EXPOSED RACEWAYS SHALL BE INSTALLED WITH RUNS PARALLEL AND/OR PERPENDICULAR WITH STRUCTURAL MEMBERS AND WALLS.
6. PROVIDE FIRE SEALING MATERIALS FOR ALL RACEWAYS PASSING THROUGH FIRE RATED PARTITIONS, WALLS AND FLOORS.

## E. HANGERS AND SUPPORTS:

1. USE CAST "C" CLAMPS, "U" STRAPS OR RING HANGERS ATTACHED TO RODS, AND/OR BRACKETS FASTENED TO STRUCTURE FOR INDIVIDUAL CONDUITS.
2. SUPPORT GROUPED RACEWAYS TOGETHER IN HORIZONTAL RUNS ON TRAPEZE HANGERS CONSTRUCTED OF UNISTRUT OR EQUAL SUSPENDED FROM CAD-PLATED STEEL RODS.

## F. WIRE AND CABLES:

1. ELECTRICAL CONDUCTORS SHALL BE OF SOFT DRAWN COPPER WITH CONDUCTIVITY 98% OF PURE COPPER, EQUAL TO GENERAL CABLE COMPANY.
2. ELECTRICAL CONDUCTORS SHALL BE SOLID FOR #10 AND SMALLER, STRANDED FOR #8 AND LARGER.
3. WIRE AND CABLE FOR ALL BRANCH CIRCUITS, FEEDERS, SUB-FEEDERS, MOTOR CIRCUITS AND HIGH AMBIENT LOCATIONS SHALL BE TYPE THWN/THHN.
4. ALL LIGHTING AND POWER CIRCUITS SHALL BE #12 OR LARGER.
5. FOR 120V CIRCUITS: HOME RUNS OVER 100' LONG, USE #10 CONDUCTORS.
6. FOR 120V CIRCUITS: HOME RUNS OVER 200' LONG, USE #8 CONDUCTORS.
7. CONSISTENTLY COLOR CODE WIRING CONTINUOUS THROUGHOUT THE WORK:
  - a. 120/240 VOLT SYSTEMS:
    1. PHASE A - RED.
    2. PHASE B - BLACK.
    3. NEUTRAL - WHITE.
    4. GROUND - GREEN.
  - b. BRANCH CIRCUIT WIRING MAY BE COMBINED INTO A SINGLE RACEWAY IN ACCORDANCE WITH NOTE 8 TO TABLES 310-16 THROUGH 310-31 OF THE NEC, UNLESS OTHERWISE NOTED.
  - c. FEEDER WIRING SHALL NOT BE COMBINED INTO A SINGLE RACEWAY.

## G. SPLICES AND TAPS:

1. STRANDED CONDUCTORS, #8 OR LARGER, SHALL BE SPLICED AND TAPPED WITH CAST COPPER SOLDERLESS PRESSURE CONNECTORS WITH MOLDED PHENOLIC INSULATING COVERS, OR TYPE XTP OR PM, OR INSULATED WITH RUBBER END FRICTION TAPE.
2. SOLID CONDUCTORS, #10 AND SMALLER, SHALL BE SPLICED WITH INSULATED SPRING CONNECTORS, IDEAL OR 3M COMPANY.

## H. GROUNDING:

1. GROUND ALL ELECTRICAL APPARATUS IN ACCORDANCE WITH NATIONAL ELECTRICAL CODE.
2. PROVIDE TWO-HOLE, PAD TYPE COMPRESSION CONNECTORS, T&B COLOR-KEYED TYPE OR BURNDY.
3. ENSURE CONTINUOUS BOND WHERE FLEXIBLE CONDUIT IS USED.

## I. OUTLET BOXES:

1. GENERAL ELECTRIC, APPLETON, STEEL CITY OR RACO HOT DIPPED GALVANIZED STEEL BOXES, OR EQUAL, UNLESS SPECIFIED OTHERWISE.
2. PROVIDE SIZE, TYPE, DESIGN, TO SUIT STRUCTURAL CONDITIONS.
3. ADEQUATE TO ACCOMMODATE SIZE AND NUMBER OF RACEWAYS, CONDUCTORS, AND DEVICE OR FIXTURE SERVED BY IT.
4. PROVIDE PLASTER RINGS AND/OR COVERS ON BOXES WHERE REQUIRED.
5. ON EXPOSED WORK, PROVIDE APPROVED CAST FERROUS ALLOY OUTLET JUNCTION BOXES AND FITTINGS.
6. FIXTURE OR DEVICE COVER SHALL COMPLETELY CONCEAL THE TYPE OUTLET BOX USED.
7. RECEPTACLES SHALL BE MOUNTED 18 INCHES ABOVE FINISHED GRADE, UNLESS OTHERWISE NOTED.

## J. PULL AND JUNCTION BOXES:

1. SHEET METAL BOXES: ANSI/NEMA OS 1: GALVANIZED STEEL.
2. SHEET METAL BOXES LARGER THAN 12 INCHES IN ANY DIMENSION SHALL HAVE A HINGED ENCLOSURE.
3. CONCRETE BOXES FOR IN-GROUND INSTALLATIONS: TYPE 4, OUTSIDE FLANGED, RECESSED COVER BOX FOR FLUSH MOUNTING, PLAIN COVER WITH NEOPRENE GASKET AND STAINLESS STEEL COVER SCREWS.
4. LOCATE PULL BOXES AND JUNCTION BOXES ABOVE ACCESSIBLE CEILINGS OR IN UNFINISHED AREAS.
5. SUPPORT PULL AND JUNCTION BOXES INDEPENDENT OF CONDUIT.
6. SET IN-GROUND PULL AND JUNCTION BOXES LEVEL AND FLUSH WITH FINISHED GRADE.
7. PROVIDE COVERPLATES FOR ALL JUNCTION BOXES.
8. INDICATE ON COVERPLATES, WITH PERMANENT MARKER, CIRCUITS CONTAINED WITHIN JUNCTION BOXES.

## K. WIRING DEVICES:

1. 125 VOLT, 20A, THREE WIRE, IVORY, DUPLEX RECEPTACLES WITH MATCHING COVERPLATES, NEMA 5-20R, LEVITON OR EQUAL BY ARROW HART.

## L. COVER PLATES:

1. ALL COVER PLATES FOR SURFACE AND CONDULET MOUNTED WIRING DEVICES SHALL BE ZINC-COATED SHEET METAL, HAVING ROUNDED OR BEVELED EDGES, AND OF THE SAME SIZE AS THE BOXES WHICH THEY COVER.

## M. PANELBOARDS:

1. THE PANELBOARDS SHALL BE ARRANGED GENERALLY AS SHOWN ON THE DRAWINGS. PANELBOARDS SHALL BE MANUFACTURED BY ONE OF THE FOLLOWING:
  - a. SIEMENS.
  - b. GENERAL ELECTRIC.
  - c. SQUARE D COMPANY.
2. PROVIDE DEAD-FRONT SAFETY TYPE LIGHTING AND APPLIANCE PANELBOARDS AS INDICATED, WITH SWITCHING AND PROTECTIVE DEVICES IN QUANTITIES, RATINGS, TYPES AND ARRANGEMENTS SHOWN, WITH ANTI-BURN SOLDERLESS PRESSURE TYPE LUG CONNECTORS APPROVED FOR COPPER CONDUCTORS.
3. EQUIP WITH COPPER BUS BARS, FULL-SIZED NEUTRAL BAR, WITH BOLT-IN TYPE HEAVY-DUTY, QUICK-MAKE, QUICK-BREAK, SINGLE-POLE CIRCUIT BREAKERS, WITH TOGGLE HANDLES THAT INDICATE WHEN TRIPPED. INTERRUPTING RATING SHALL BE IN EXCESS OF THE AVAILABLE FAULT CURRENT AT THE PANEL IN ACCORDANCE WITH UL LISTING FOR SIZES INVOLVED, BUT NO LESS THAN 10,000 RMS SYMMETRICAL AMPERES.
4. PROVIDE SUITABLE LUGS ON NEUTRAL BUS FOR EACH OUTGOING FEEDER REQUIRED. PROVIDE UNINSULATED GROUNDING BARS SUITABLE FOR BOLTING TO ENCLOSURES. SELECT ENCLOSURES FABRICATED BY SAME MANUFACTURER AS PANELBOARDS, WHICH MATE PROPERLY WITH PANELBOARDS.

## N. LIGHTING FIXTURES:

1. ALL LIGHTING FIXTURES SHOWN ON THE DRAWINGS ARE FURNISHED AND INSTALLED BY THIS CONTRACTOR, INCLUDE ALL COSTS NECESSARY FOR THE INSTALLATION INCLUDING MOUNTING, SUPPORTS AND FOUNDATIONS.
2. FURNISH ALL ACCESSORIES REQUIRED FOR EACH AND EVERY FIXTURE. PROVIDE APPROPRIATE HANGER, BARS, ETC. OF NON-FERROUS OR CADMIUM PLATED STEEL MATERIALS, TO SUPPORT FIXTURES.
3. REFERENCE NEW LIGHTING FIXTURE SCHEDULE.

## O. NAMEPLATES:

1. DISTRIBUTION AND BRANCH CIRCUIT PANELBOARDS: PROVIDE ENGRAVED, LAMACOID PLASTIC NAMEPLATE SHOWING PANELBOARD DESIGNATION AND SOURCE (CIRCUIT DESIGNATION) OF POWER.
2. DISCONNECT SWITCHES: PROVIDE ENGRAVED, LAMACOID PLASTIC NAMEPLATE SHOWING EQUIPMENT DESIGNATION AND SOURCE (CIRCUIT DESIGNATION) OF POWER. PROVIDE NEW NAMEPLATES FOR EQUIPMENT BEING REFERRED.
3. DISTRIBUTION AND BRANCH CIRCUIT PANELBOARDS: PROVIDE NEATLY TYPEWRITTEN CIRCUIT DIRECTORY IN CARDHOLDER INSIDE PANELBOARD DOOR.

## P. SUBMITTALS:

1. PRODUCT DATA: SUBMIT THE FOLLOWING:
  - a. MATERIALS LIST OF ITEMS PROPOSED TO BE PROVIDED UNDER DIVISION 16.
  - b. MANUFACTURER'S SPECIFICATIONS AND OTHER DATA NEEDED TO PROVE COMPLIANCE WITH THE SPECIFIED ITEMS.
2. SUBMITTALS REQUIRED OF MATERIALS AND EQUIPMENT UNDER THIS SECTION INCLUDE THE FOLLOWING:
  - a. PANELBOARDS.
  - b. CIRCUIT BREAKERS.
  - c. LIGHTING FIXTURES AND POLES.
  - d. CONDUCTORS.
  - e. CONDUIT AND FITTINGS.
  - f. CABINETS.
  - g. CONTACTORS, RELAYS, TIMECLOCKS, AND CONTROLS.
  - h. WIRING DEVICES AND COVERPLATES.
  - i. GROUNDING AND BONDING SYSTEM.

## Q. SUBSTITUTIONS:

1. SUBMITTALS FOR "EQUAL" ITEMS SHALL, WHERE APPLICABLE, INCLUDE THE FOLLOWING DATA WHICH ARE NOT NECESSARILY REQUIRED FOR SPECIFIED ITEMS:
  - a. PERFORMANCE CHARACTERISTICS
  - b. MATERIALS
  - c. FINISH
  - d. CERTIFICATION OF CONFORMANCE WITH SPECIFIED CODES AND STANDARDS.
2. SUBMITTALS OF "EQUAL" COMPONENTS OR SYSTEMS MAY BE REJECTED IF:
  - a. THE MATERIALS OR EQUIPMENT WOULD NECESSITATE THE ALTERATION OF ANY PORTION OF THE MECHANICAL, ELECTRICAL, ARCHITECTURAL OR STRUCTURAL DESIGN.
  - b. DIMENSIONS VARY FROM THE SPECIFIED MATERIAL OR EQUIPMENT IN SUCH A MANNER THAT THE ACCESSIBILITY OR CLEARANCES ARE IMPAIRED ON THE WORK OF OTHER TRADES IS ADVERSELY AFFECTED.
3. PROPOSED SUBSTITUTIONS FOR MATERIALS OR EQUIPMENT MUST BE SUBMITTED TEN (10) DAYS PRIOR TO FINAL BID DATE FOR CONSIDERATION AS APPROVED OR EQUALS. OTHERWISE, SUCH SUBSTITUTIONS WILL NOT BE PERMITTED. PROPOSALS FOR SUBSTITUTIONS SHALL BE MADE ONLY BY THE BIDDERS, MANUFACTURERS, DISTRIBUTORS AND SUBCONTRACTORS SHALL NOT MAKE PROPOSALS TO THE OWNER FOR SUBSTITUTIONS.
4. NO SUBSTITUTIONS SHALL BE MADE UNLESS AUTHORIZED IN WRITING BY THE OWNER. SHOULD A SUBSTITUTION BE ACCEPTED, AND SHOULD THE SUBSTITUTE MATERIAL PROVE DEFECTIVE OR OTHERWISE UNSATISFACTORY FOR THE SERVICE INTENDED, AND WITHIN THE GUARANTEE PERIOD, THE CONTRACTOR SHALL REPLACE THIS MATERIAL OR EQUIPMENT WITH MATERIAL OR EQUIPMENT SPECIFIED, AT HIS OWN EXPENSE, AND TO THE SATISFACTION OF THE OWNER.

## R. GUARANTEE:

1. GUARANTEE ENTIRE INSTALLATION TO BE IN GOOD REPAIR AND PROPER WORKING ORDER FOR A PERIOD OF ONE-YEAR FOLLOWING DATE OF FINAL ACCEPTANCE.

## S. CLOSE OUT DOCUMENTS:

1. PROVIDE OWNER WITH AS-BUILT DRAWINGS, MANUFACTURER'S WARRANTIES AT FINAL ACCEPTANCE OF INSTALLATION.

## END OF SPECIFICATION

DRAWN: C.A.D.  
 CHECKED: J.W.  
 DATE: Oct. 2022  
 SCALE: As Shown  
 JOB NO.: 22-069

